





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CHECKED	R.LAUFER	01/2018 DATE					APPROVED JOHN PURDY ENGINEERING	01/25/2018 DATE	APPROVED DEBDAS GHOSAL ENGINEER OF RECO	plewood.	01/25/2018 DATE	м NO. М1301	CONTRACT NO. FQ18064	SCALE 1/16"=1'-0"	DRAWING NO. K08-P-110	SHEET NO. 460 of 503	

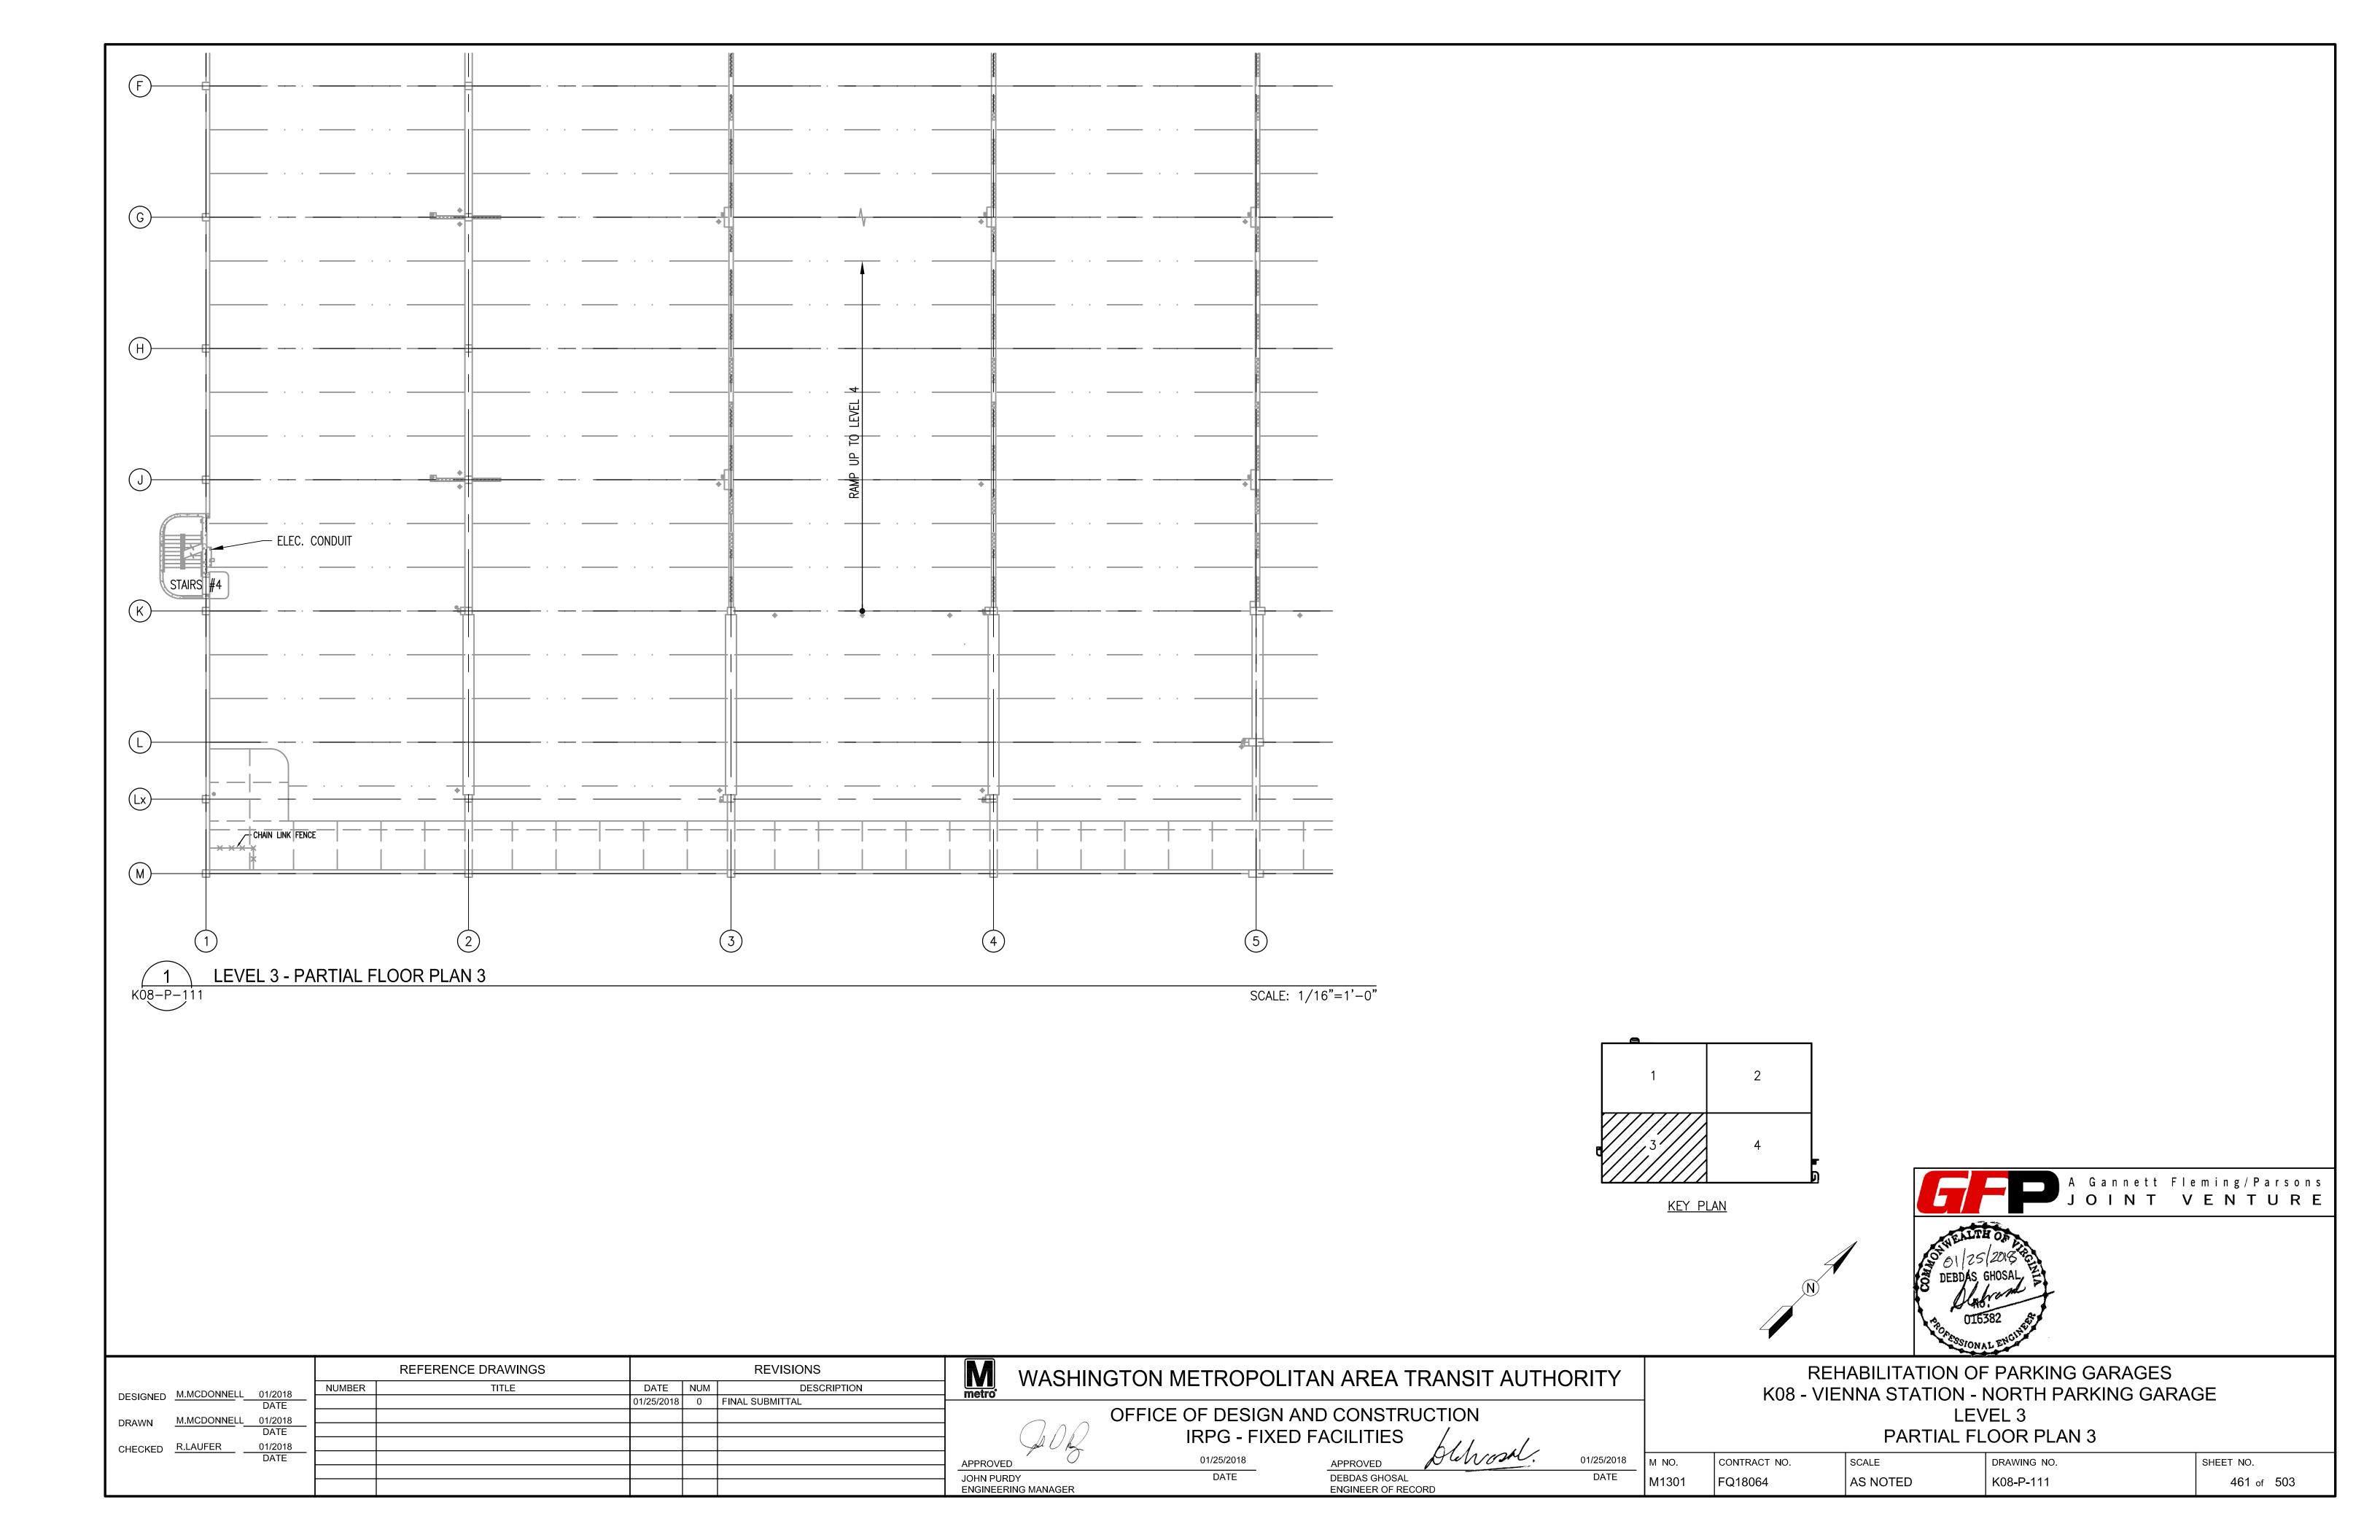

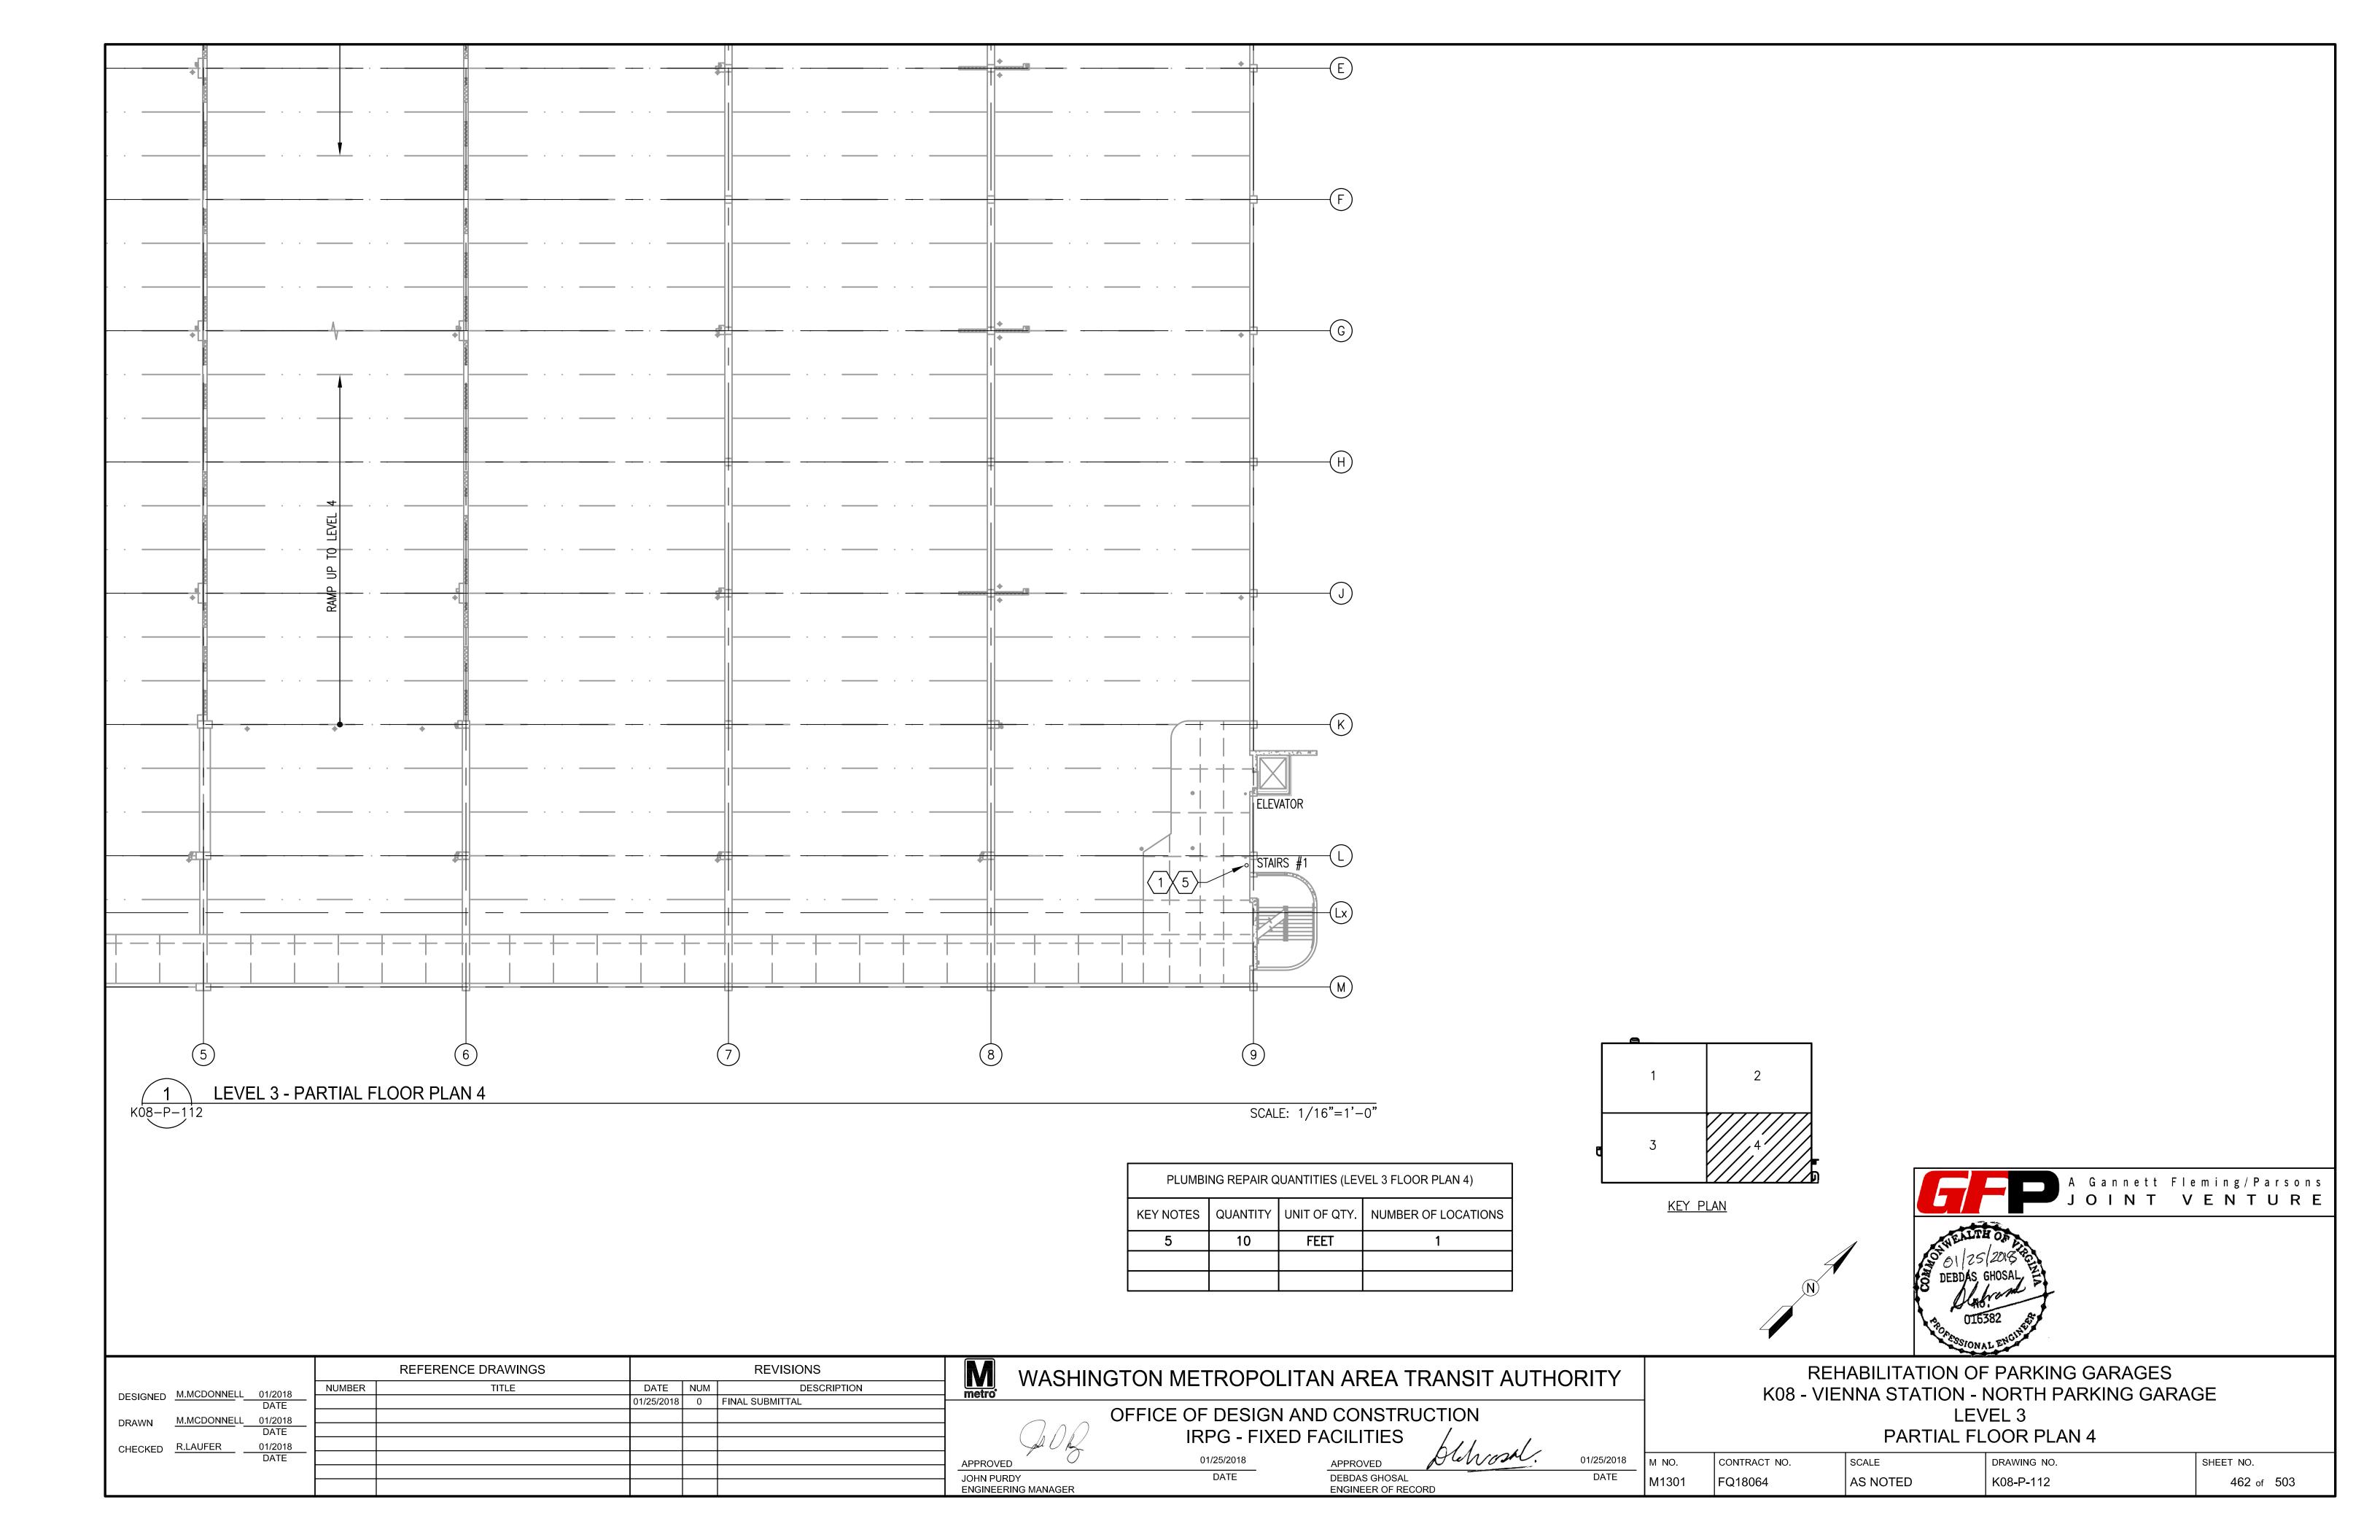


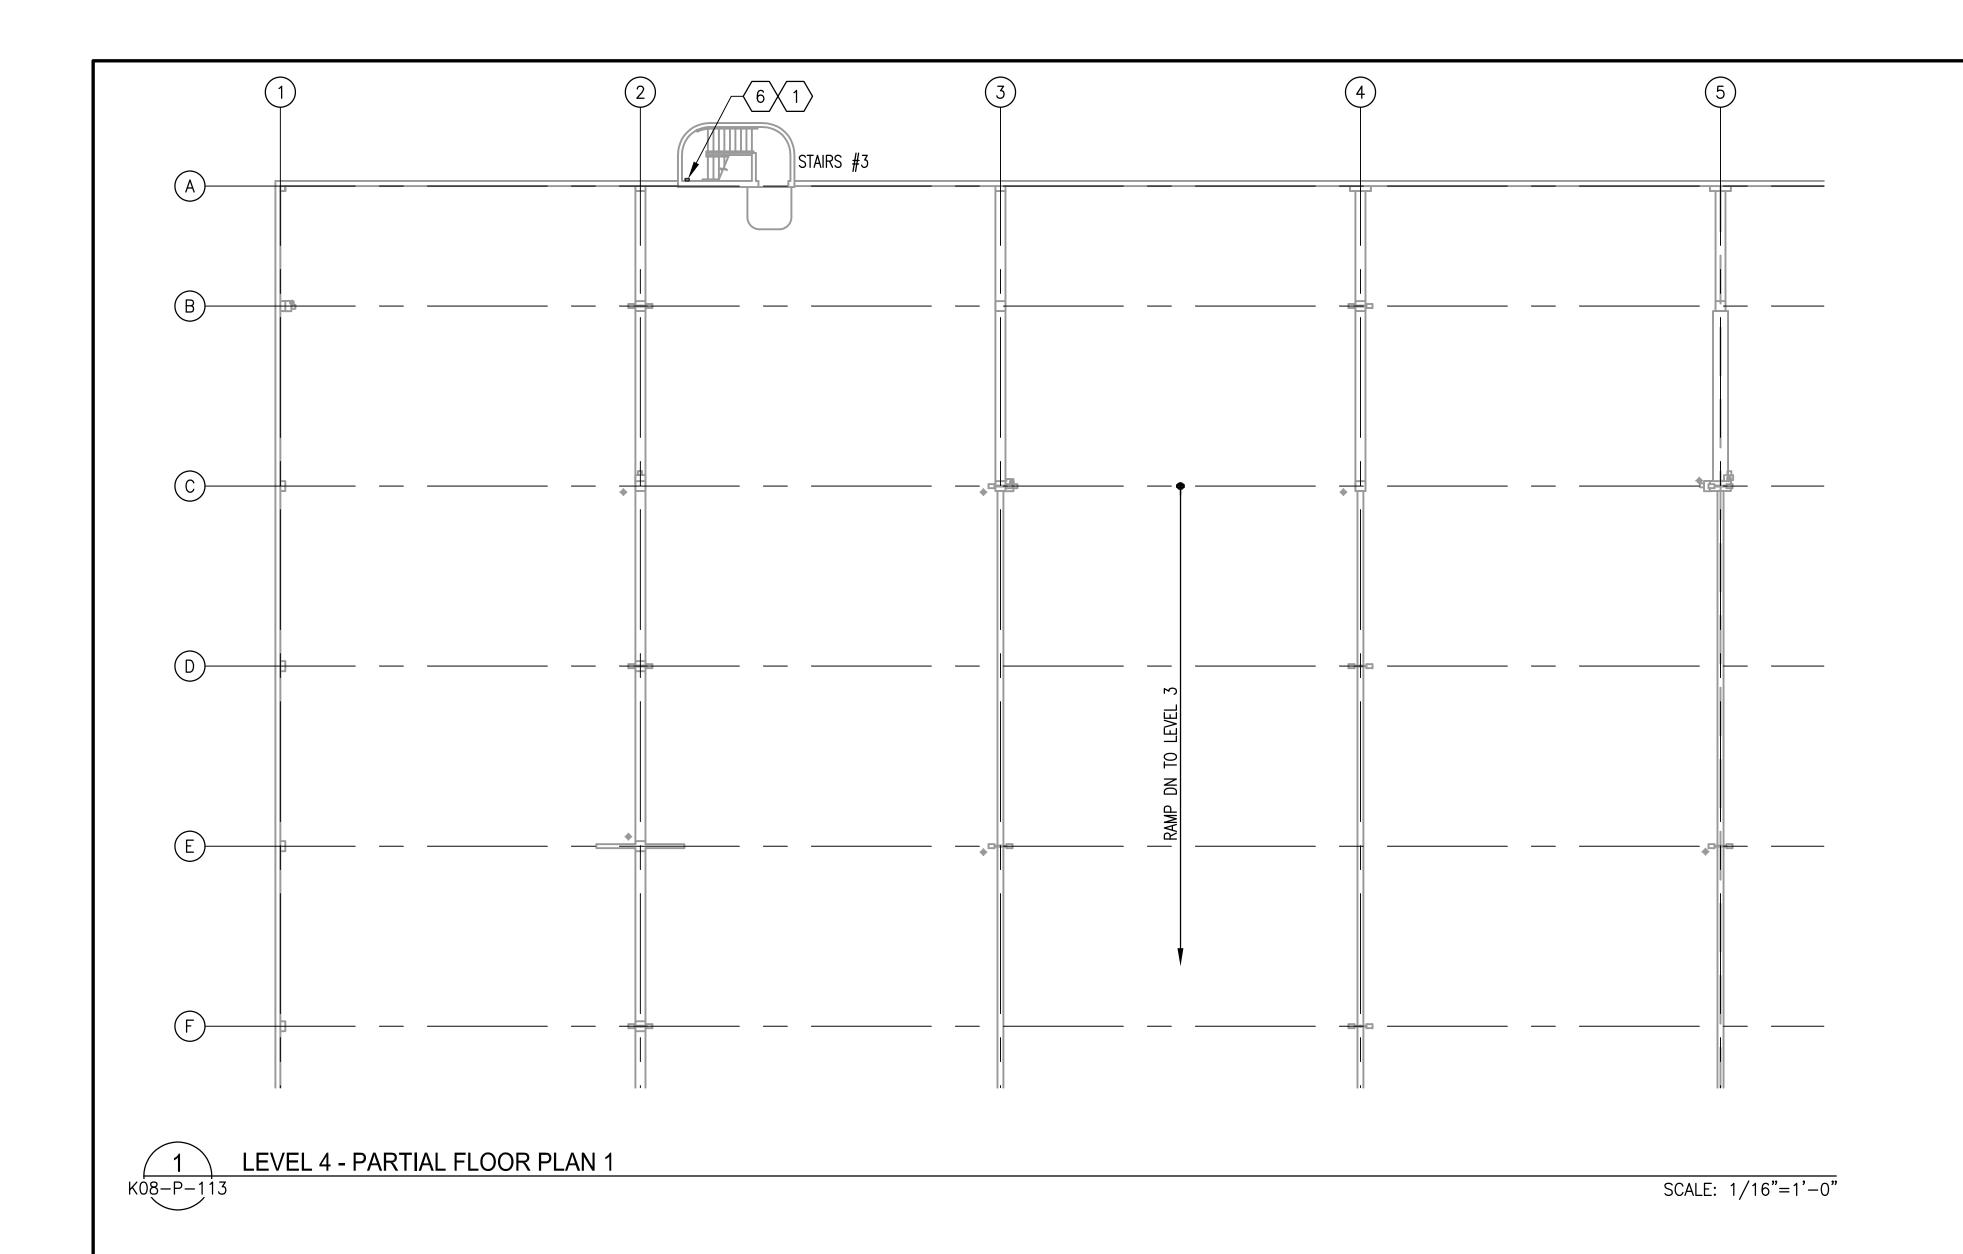

PLUMBING REPAIR QUANTITIES (LEVEL 4 FLOOR PLAN 1) KEY NOTES QUANTITY UNIT OF QTY. NUMBER OF LOCATIONS UNIT

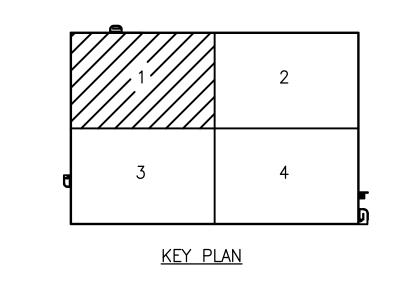

01/25/2018 DATE

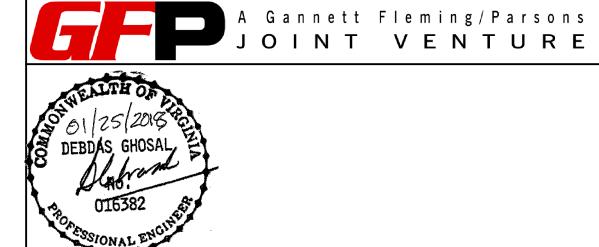

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WASHINGTON METROPOLITAN AREA TRANSIT AUTHORITY OFFICE OF DESIGN AND CONSTRUCTION


IRPG - FIXED FACILITIES

01/25/2018 DEBDAS GHOSAL ENGINEER OF RECORD

REHABILITATION OF PARKING GARAGES K08 - VIENNA STATION - NORTH PARKING GARAGE LEVEL 4


463 of 503


	PARTIAL FLOOR PLAN 1													
M NO.	CONTRACT NO.	SCALE	DRAWING NO.	SHEET NO.										
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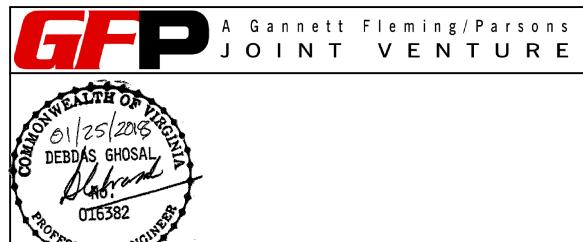


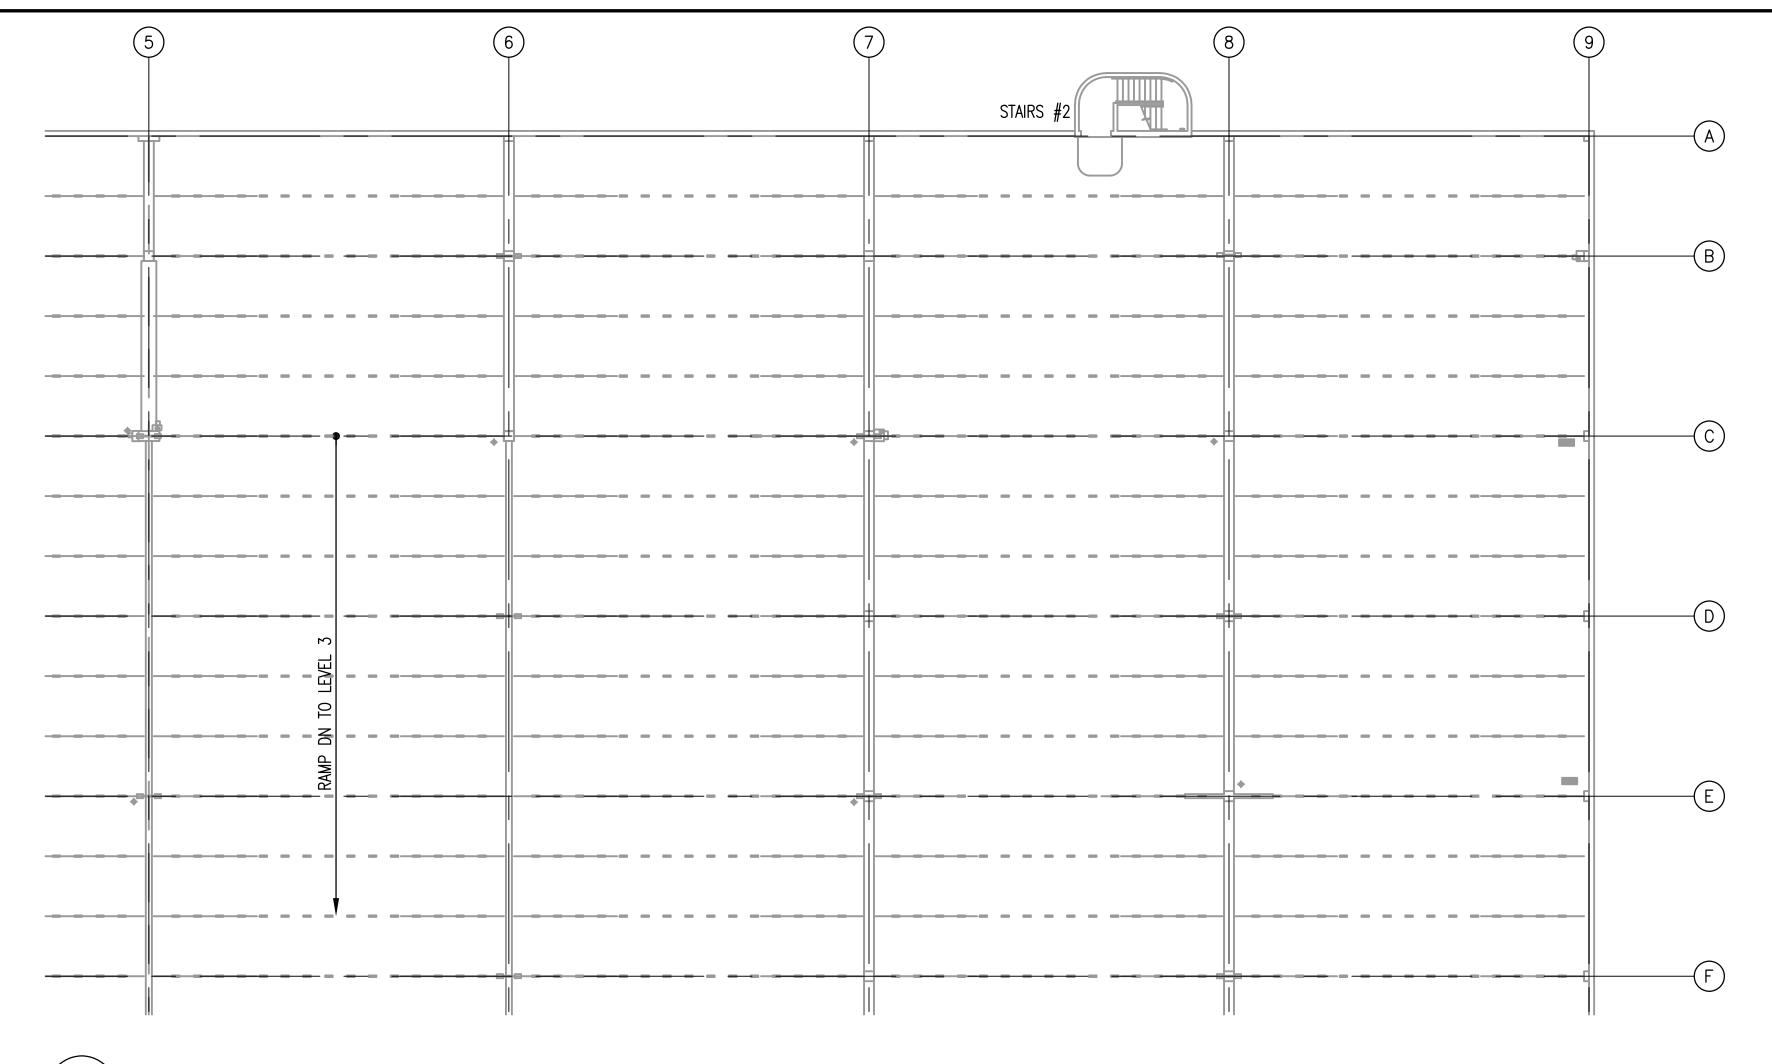LEVEL 4 - PARTIAL FLOOR PLAN 2

SCALE: 1/16"=1'-0"



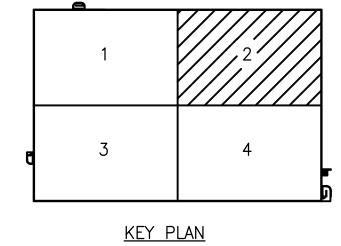

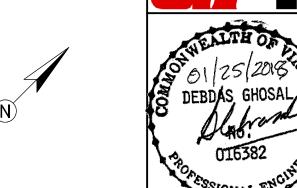

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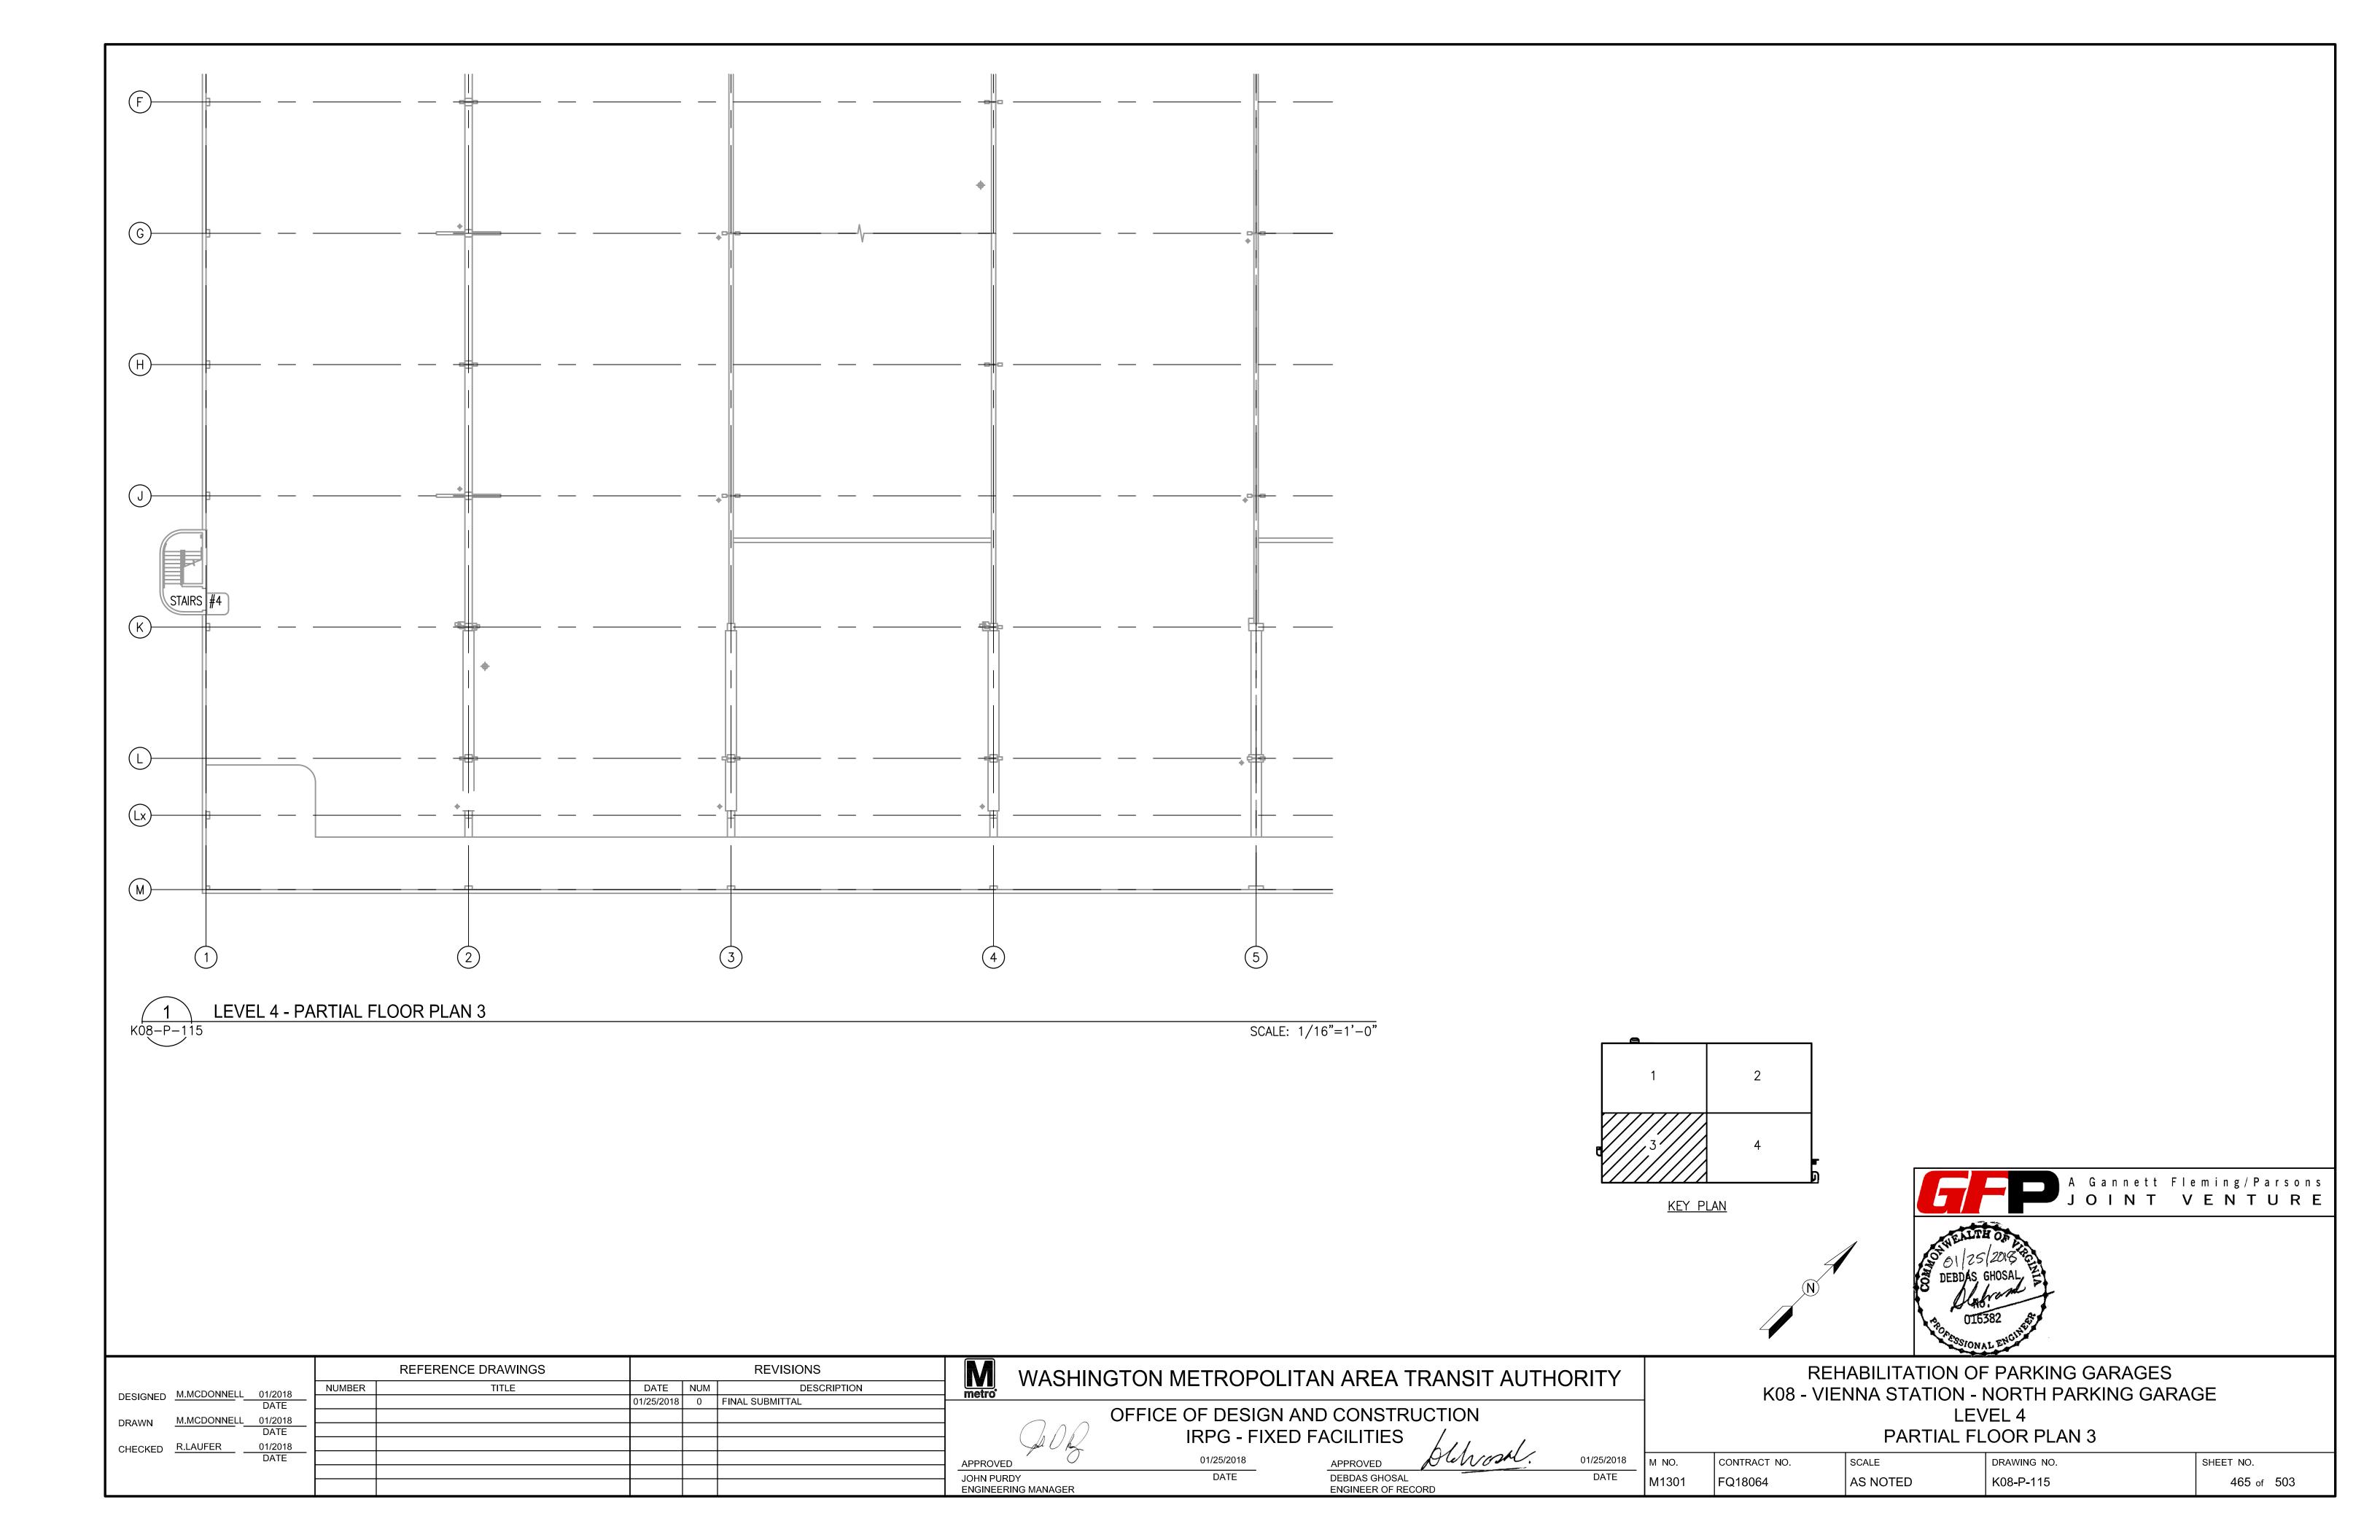
WASHINGTON METROPOLITAN AREA TRANSIT AUTHORITY


OFFICE OF DESIGN AND CONSTRUCTION IRPG - FIXED FACILITIES

01/25/2018 DEBDAS GHOSAL ENGINEER OF RECORD

REHABILITATION OF PARKING GARAGES K08 - VIENNA STATION - NORTH PARKING GARAGE LEVEL 4 DARTIAL FLOOR DLANG

			PARTIAL FL	OUR PLAN 2	
18	M NO.	CONTRACT NO.	SCALE	DRAWING NO.	SHEET NO.
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A AMPERES/AMMETER/AUTO AC ALTERNATING CURRENT CORR CORR CORPAIR COMPRESSOR ACT ABOVE COUNTER TOP 1/C SING MULTI (X D AFF ABOVE FINISH FLOOR DET DETAIN DEMO. DE	ONDUCTOR, CONDITIONING ETR ONTROL/CONTINUATION FA ORRIDOR FACP	EXISTING TO REMAIN FIRE ALARM			МН	MOUNTING LIFTOUT / MANUALE	DEAEDT DEA			
AC ALTERNATING CURRENT /AIR COMPRESSOR CU COPP ACT ABOVE COUNTER TOP A/C AIR CONDITIONING AFF ABOVE FINISH FLOOR APPROX APPROXIMATELY DEMO. DEM AT AMPERE TRIP DIA DIAM AWG AMERICAN WIRE GAUGE AHJ AUTHORITY HAVING JURISDICTION DET DETA DETA DISC DISC DISC	·	FIRE ALARM			1911 1	MOUNTING HEIGHT/ MANHOLE	RECEPT., REC	RECEPTACLE	VA	VOLT-AMPERE
ACT ABOVE COUNTER TOP 1/C SING MULTI (X D) AFF ABOVE FINISH FLOOR DET DETA APPROX APPROXIMATELY DEMO. DEMO DIA DIAM AWG AMERICAN WIRE GAUGE DISC DISC AHJ AUTHORITY HAVING JURISDICTION DPDT DOUL AFCI ARC FAULT CIRCUIT INTERRUPTER DWG DRAW BATT BATTERY DWG DRAW BC BARE COPPER EF EXHAUST	ORRIDOR FACP		INCAND	INCANDESCENT	MIN	MINIMUM	REF	REFERENCE	٧	VOLT/VOLTMETER
ACT ABOVE COUNTER TOP 1/C SING A/C AIR CONDITIONING X/C AFF ABOVE FINISH FLOOR DET DETA APPROX APPROXIMATELY DEMO. DEM AT AMPERE TRIP DIA DIAM AWG AMERICAN WIRE GAUGE DISC DISC AHJ AUTHORITY HAVING JURISDICTION DPDT DOUB AFCI ARC FAULT CIRCUIT INTERRUPTER DPST DOUB BATT BATTERY DWG DRAW BC BARE COPPER EF EXHAURTER		FIRE ALARM CONTROL PANEL		INDICATION	MISC	MISCELLANEOUS	REV	REVISION/REVERSE	VD	VOLTAGE DROP
A/C AIR CONDITIONING X/C MULT (X D) AFF ABOVE FINISH FLOOR APPROX APPROXIMATELY DEMO. DEM AT AMPERE TRIP DIA DIAM AWG AMERICAN WIRE GAUGE AHJ AUTHORITY HAVING JURISDICTION DPDT DOUB AFCI ARC FAULT CIRCUIT INTERRUPTER DWG DRAM BC BARE COPPER DET DETA DEMO. DIAM DIAM AWG AMERICAN WIRE GAUGE DISC DISC DISC DOUB DEMO. DISC DISC DISC DISC DISC DISC DISC DEMO. DISC	OPPER FCU	FAN COIL UNIT	JB }	JUNCTION BOX	MLO	MAIN LUGS ONLY	RGS	RIGID GALVANIZED STEEL CONDUIT	W	WATTS/WIRE/WIDTH/WIDE
AFF ABOVE FINISH FLOOR AFF ABOVE FINISH FLOOR APPROX APPROXIMATELY DEMO. DEMO. AT AMPERE TRIP DIA DIAM AWG AMERICAN WIRE GAUGE DISC DISC AHJ AUTHORITY HAVING JURISDICTION DPDT DOUB AFCI ARC FAULT CIRCUIT INTERRUPTER DWG DRAW BC BARE COPPER EF EXHA	NGLE CONDUCTOR CABLE FIXT	FIXTURE	J-BOX		MTD	MOUNTED	RM	ROOM	W/	WITH
AFF ABOVE FINISH FLOOR DET DETA APPROX APPROXIMATELY DEMO. DEMO AT AMPERE TRIP DIA DIAM AWG AMERICAN WIRE GAUGE DISC DISC AHJ AUTHORITY HAVING JURISDICTION DPDT DOUB AFCI ARC FAULT CIRCUIT INTERRUPTER DPST DOUB BATT BATTERY DWG DRAM BC BARE COPPER EF EXHA	JLTICONDUCTOR CABLE FLA	FULL LOAD AMPS	k	THOUSAND/KILO	MTG	MOUNTING	SCH	SCHEDULE	W/ O	WITHOUT
APPROX APPROXIMATELY DEMO. DEMO AT AMPERE TRIP DIA DIAM AWG AMERICAN WIRE GAUGE DISC AHJ AUTHORITY HAVING JURISDICTION DPDT DOUB AFCI ARC FAULT CIRCUIT INTERRUPTER DPST DOUB BATT BATTERY DWG DRAW BC BARE COPPER EF EXHA	DENOTES # OF CONDUCTORS) FLEX	FLEXIBLE	kcmil	THOUSAND CIRCULAR MIL	MTR	MOTOR	SEC	SECONDARY/SECOND	WP	WEATHERPROOF
AT AMPERE TRIP DIA DIAM AWG AMERICAN WIRE GAUGE DISC AHJ AUTHORITY HAVING JURISDICTION DPDT DOUB AFCI ARC FAULT CIRCUIT INTERRUPTER DPST DOUB BATT BATTERY DWG DRAM BC BARE COPPER EF EXHA	ETAIL FLUOR	FLUORESCENT	KV	KILOVOLT	N	NEUTRAL/NEUTRAL CONTACTOR	SHT	SHEET	XFMR	TRANSFORMER
AWG AMERICAN WIRE GAUGE DISC AHJ AUTHORITY HAVING JURISDICTION DPDT DOUG AFCI ARC FAULT CIRCUIT INTERRUPTER DPST DOUG BATT BATTERY DWG DRAW BC BARE COPPER EF EXHA	EMOLISH FO	FIBER OPTIC CABLE	KVA	KILOVOLT-AMPERES	NEC	NATIONAL ELECTRICAL CODE	SP	SPLICE POINT/SPARE	Z	IMPEDANCE
AHJ AUTHORITY HAVING JURISDICTION DPDT DOUB AFCI ARC FAULT CIRCUIT INTERRUPTER DPST DOUB BATT BATTERY DWG DRAM BC BARE COPPER EF EXHA	AMETER FP	FIRE PROTECTION	KVAR	KILOVAR	NEMA	NATIONAL ELECTRICAL	SPECS	SPECIFICATIONS		
AFCI ARC FAULT CIRCUIT INTERRUPTER DPST DOUB BATT BATTERY DWG DRAW BC BARE COPPER EF EXHA	SCONNECT FT(')	FEET/FOOT	KW	KILOWATT	l	MANUFACTURERS ASSOCIATION	SPDT	SINGLE POLE DOUBLE THROW		
BATT BATTERY DWG DRAN BC BARE COPPER EF EXHA	OUBLE POLE, DOUBLE THROW FUT	FUTURE	LC	LIGHTING CONTACTOR	NF	NON-FUSED	SPST	SINGLE POLE SINGLE THROW		
BC BARE COPPER EF EXHA	OUBLE POLE, SINGLE THROW GFI	GROUND FAULT INTERRUPTER	LDCP	LEAK DETECTOR CONTROL PANEL	NL	NIGHT LIGHT	STD	STANDARD		
	RAWING GFCI	GROUND FAULT CIRCUIT INTERRUPT	LFACP	LOCAL FIRE ALARM CONTROL PANEL	No./#	NUMBER	SW	SWITCH		
	KHAUST FAN GF	GROUND FAULT RELAY	LTG	LIGHT/LIGHTING	NTS	NOT TO SCALE	SWBD	SWITCHBOARD		
	LECTRICAL GUB	> GROUND	LV	LOW VOLTAGE	ø	PHASE/DIAMETER	SWGR	SWITCHGEAR		
BLDG BUILDING EL ELEV	_EVATION GND		LVL	LEVEL	OC	OVERCURRENT	SYS	SYSTEM		
C CONDUIT/ CONDUCTOR/ COMMON ELEV	HP	HORSEPOWER	LVPC	LOW VOLTAGE POWER & CONTROL	OL	OVERLOAD RELAY CONTACTS	T	TECHNICAL/TRAY/TRANSFORMER		
CAT CATALOG EMERG EMER	MERGENCY HPF	HIGH POWER FACTOR	М	METER/MANUAL	Р	POLE/POWER	T1/T2	TRANSFORMER T1-T2		
CAU COMPRESSED AIR UNIT EMT ELEC	LECTRIC METALLIC TUBING HPS	HIGH PRESSURE SODIUM	MA	MILLIAMPS	PB	PULL BOX/PUSHBUTTON	TBD	TO BE DETERMINED		
	NCLOSURE HVAC {	HEATING, VENT, AND AIR CONDITIONING	MAX	MAXIMUM	PNL	PANEL	TYP	TYPICAL		
CONTROL BUILDING EQ EQUI	QUIPMENT HV	HIGH VOLTAGE	MCB	MAIN CIRCUIT BREAKER	PPB	POWER PULL BOX	U	UTILITY		
CFE/CI CONTRACTOR FURNISHED EQUIPMENT/ EQUIP	HW	HOT WATER	MCC	MOTOR CONTROL CENTER	PRI	PRIMARY	UG	UNDERGROUND		
' I CONTRACTOR INSTALLED	KISTING TO REMAIN HZ	HERTZ	MCD	MOTORIZED CONTROL DAMPER	PROVIDE <	FURNISH, INSTALL, AND CONNECT	UH	UNIT HEATER		
CKT CIRCUIT EWC ELEC	LECTRIC WATER COOLER IEEE	INSTITUTE OF ELECTRICAL	MECH	MECHANICAL	Į	COMPLETE.	UON	UNLESS OTHERWISE NOTED		
COMM COMMUNICATION EWH ELEC	LECTRICAL WATER HEATER	AND ELECTRONIC ENGINEERS	MFG	MANUFACTURING	PWR	POWER	UPS	UNINTERRUPTIBLE POWER SUPPLY		
CONN CONNECTION EX EXIST	KISTING	ISOLATED GROUND	MFGR	MANUFACTURER	PVC	POLYVINYL CHLORIDE				

ENGINEERING MANAGER

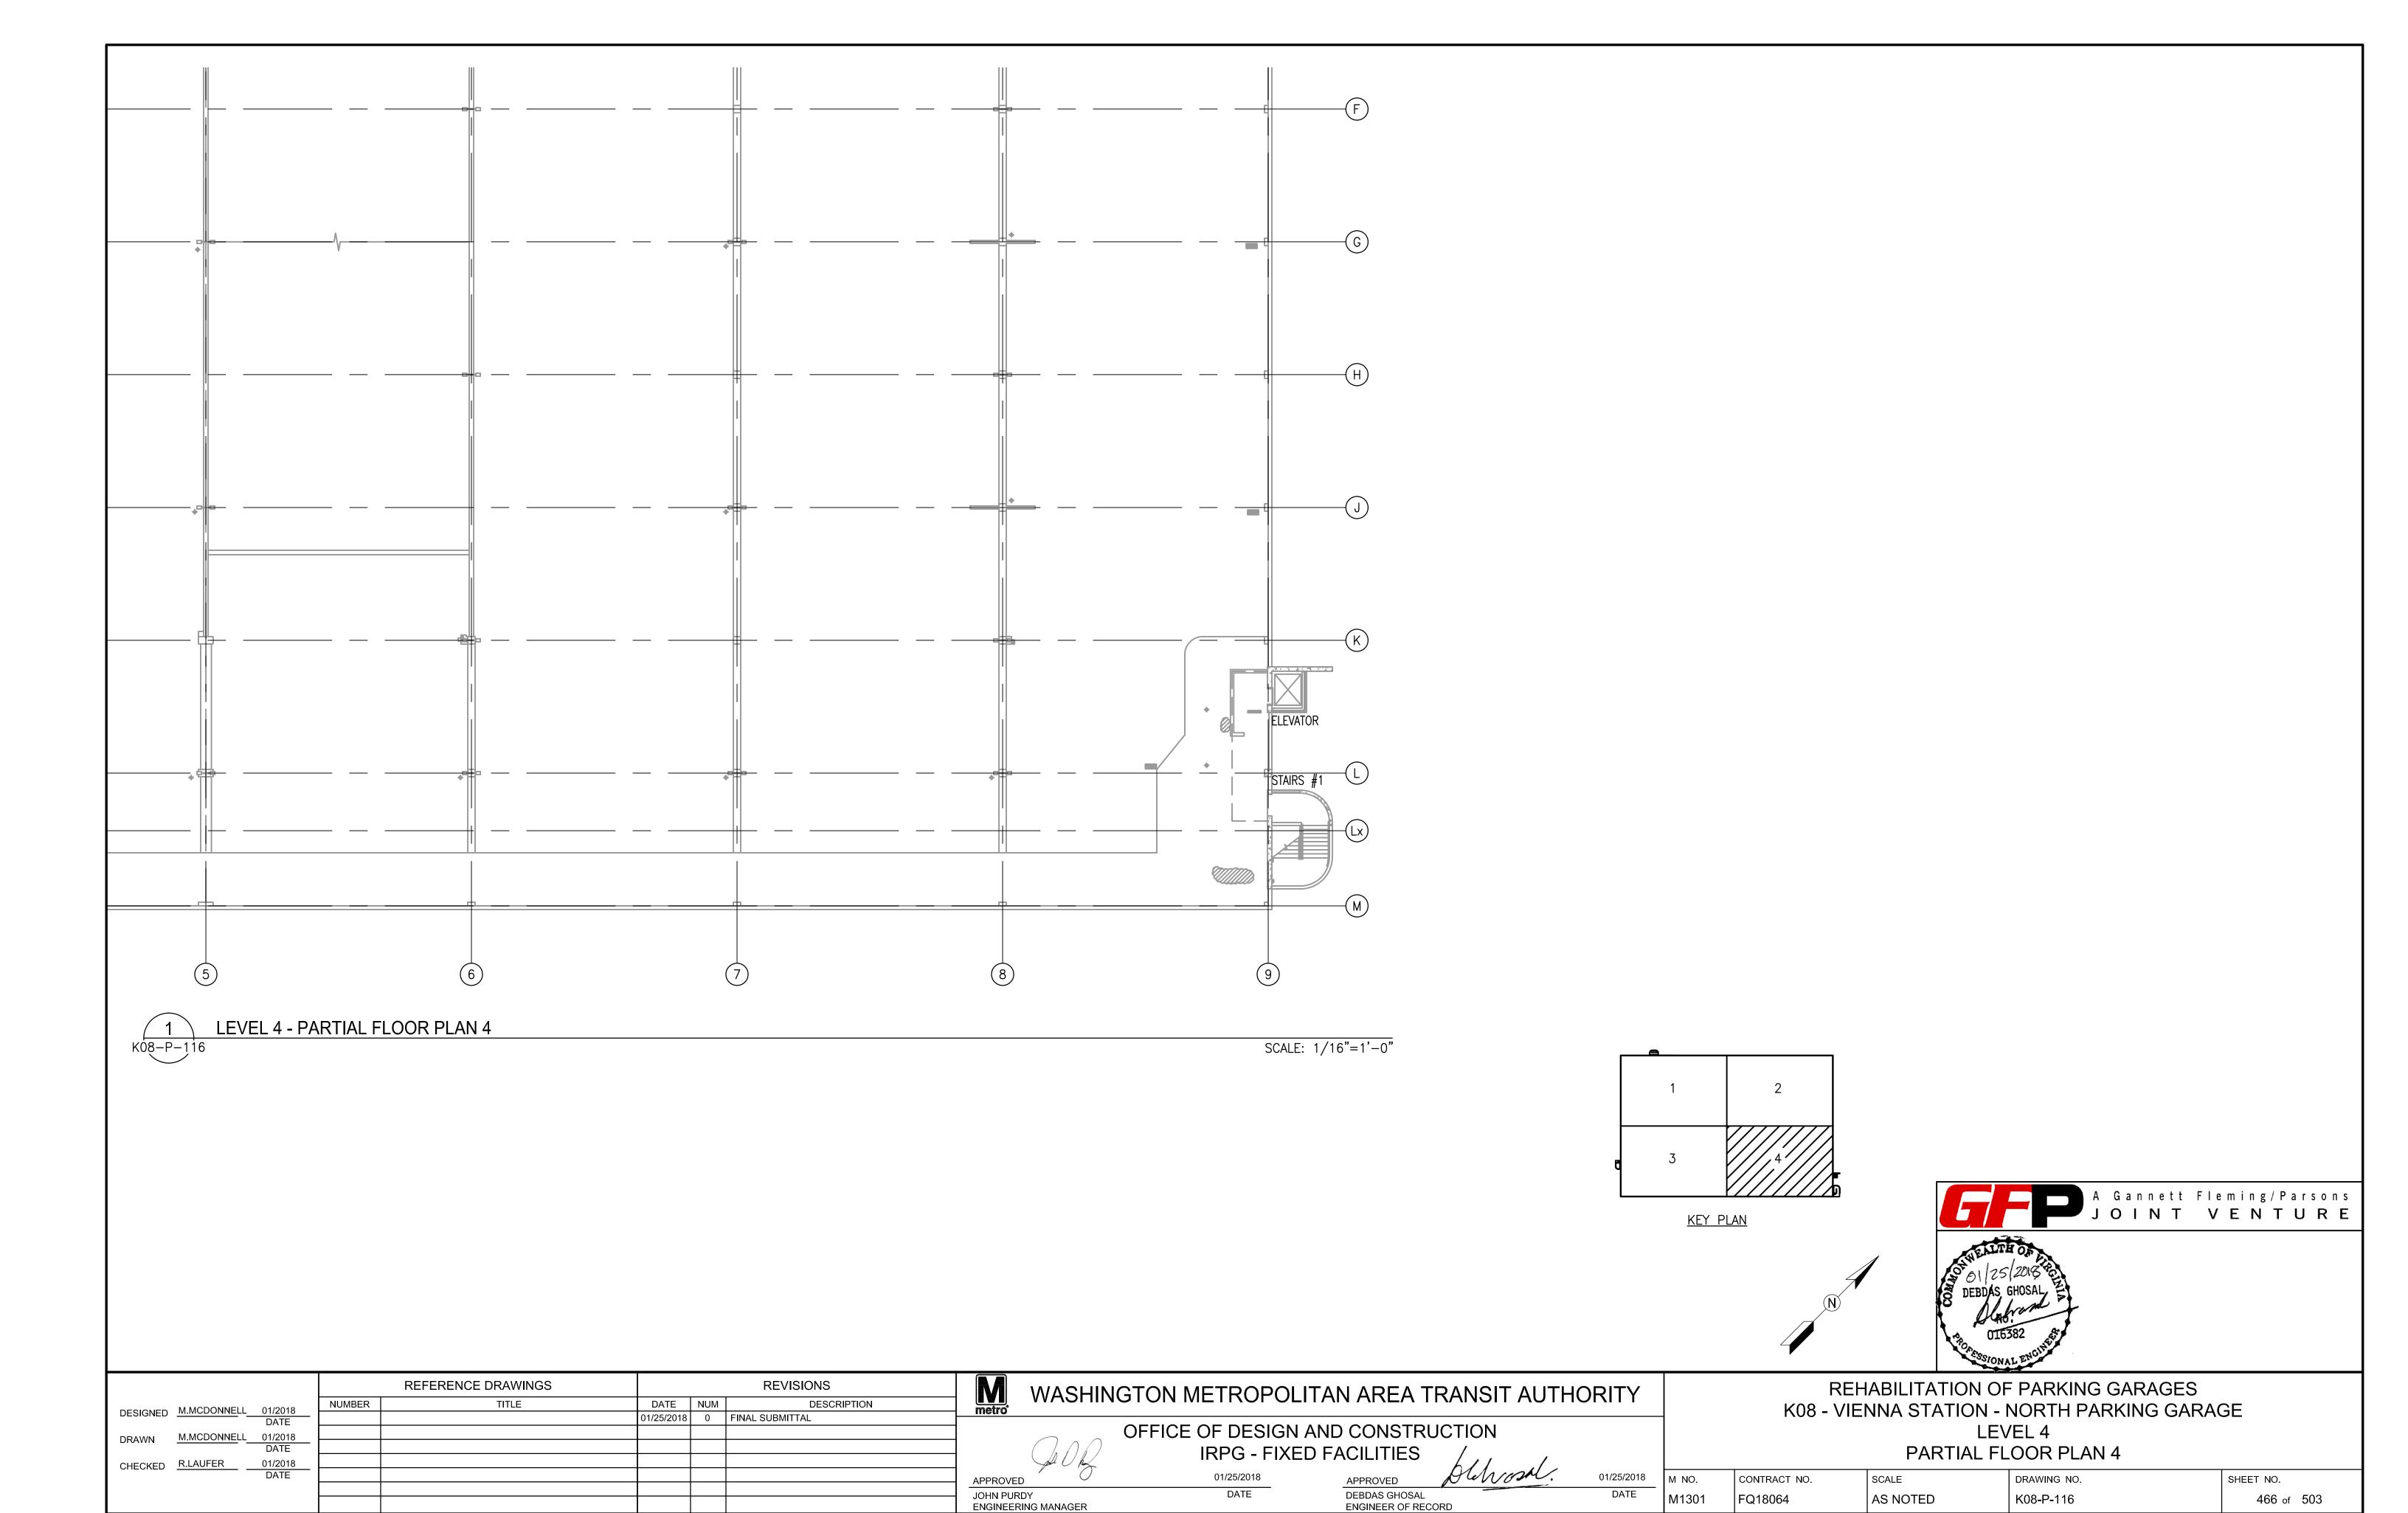COORDINATE ALL ELECTRICAL WORK WITH ALL FACILITY ENGINEERS AND MAINTENANCE PERSONNEL TO AVOID CONFLICTS AND UNFORESEEN OUTAGES. COORDINATE DRAWINGS IN ACCORDANCE WITH THE REQUIREMENTS OF THE SPECIFICATIONS.

CONTRACTOR SHALL VERIFY EXISTING SITE CONDITIONS PRIOR TO THE START OF ANY WORK. CONTRACTOR SHALL NOT PROCEED WITH ANY ELECTRICAL, TELECOMMUNICATION, FIRE ALARM, SPECIAL SYSTEMS, OR LIGHTING CIRCUITRY MODIFICATION TO THE EXISTING FACILITY'S SYSTEMS UNLESS AUTHORIZED BY FACILITY ENGINEERS, IN WRITING.

AND ANY OTHER EQUIPMENT ARE TO BE DISCARDED AFTER APPROVAL OF FACILITY ENGINEERS, OR THEIR REPRESENTATIVE. 4. DISCARDED MATERIALS SHALL BE EVALUATED FOR RECYCLABLE MATERIALS

3. ALL DEMOLITION MATERIALS, WIRING, DEVICES, LIGHTING FIXTURES, LAMPS

AND SHALL BE DISPOSED OF IN ACCORDANCE TO THE FACILITY'S RECYCLABLE PROGRAM, GUIDELINES, AND POLICIES.

5. ALL CONTRACTORS AND FACILITY PERSONNEL SHALL BE RESPONSIBLE TO MAINTAIN HOUSEKEEPING PRACTICES ON THE PREMISES OF THE WORK SITE AND SHALL ADHERE TO THE ALL RULES, POLICIES, AND GUIDELINES SET FORTH IN THE FACILITIES SAFETY IN THE WORK AREA PROGRAM. 6. ELECTRICAL EQUIPMENT, DEVICES, LIGHTING FIXTURES, CONDUIT,

ENCLOSURES, TROUGHS, DISCONNECT SWITCHES, MOUNTING HARDWARE, ETC., INDICATED ON THE DEFICIENCY DRAWINGS ARE TO BE REMOVED AND STORED OFF THE PREMISES, UNLESS OTHERWISE NOTED. 7. CONTRACTOR AND FACILITY PERSONNEL SHALL COORDINATE WITH THE

WORK WITH THE DEFICIENCY DRAWINGS FOR RELATED DISCIPLINES AND SHALL REMOVE ELECTRICAL EQUIPMENT AS REQUIRED TO COMPLETE THE PROJECT. CONTRACTOR SHALL ENSURE ALL POWER IS OFF, LOCKOUT

PROPER PRECAUTIONS HAVE BEEN TAKEN TO ALLOW FOR A SAFE PROJECT SITE.

SEALING AND FINISHING ANY OPENINGS OR HOLES UNCOVERED DURING MUST MAINTAIN THE INTEGRITY OF THE REPAIRED EXISTING WALLS, AND/OR FLOOR SLAB BY USING THE THE APPROPRIATE INDUSTRY APPROVED REPAIR METHOD.

MINIMIZE ALL POWER OUTAGES. CONTRACTOR SHALL COORDINATE ALL REQUIRED POWER OUTAGES WITH THE FACILITIES DIRECTOR/ENGINEER. 11. THE CONTRACTOR AND FACILITY PERSONNEL SHALL COORDINATE WITH THE CORRECTIVE WORK NOTES, AND/OR DRAWINGS, AND THAT ALL

STRUCTURAL, AND MECHANICAL), FOR ANY OTHER RELATED WORK REFERRING TO THE WALLS, CEILINGS, OR FLOORS IN THE AREA OF

CODES AND STANDARDS

ALL WORK OF THIS CONTRACT SHALL BE IN ACCORDANCE WITH: 1.1. WHITE FLINT: 2015 INTERNATIONAL BUILDING CODE: NFPA 70, 2014 NATIONAL ELECTRICAL CODE, EXCUTIVE REGULATION ER 6-16; 2015 INTERNATIONAL ENERGY CONSERVATION CODE; MARYLAND BUILDING REHABILITATION CODE; 2012 GREEN BUILDING CODE, EXECUTIVE REGULATION 21-17 AMMII. 1.2. NEW CARROLLTON: 2015 INTERNATIONAL BUILDING CODE; PRINCE GEORGE'S

COUNTY ELECTRICAL CODE, SUBTITLE 9; NFPA 70, 2014 NATIONAL ELECTRICAL CODE; 2015 INTERNATIONAL ENERGY CONSERVATION CODE. 1.3. LARGO TOWN CENTER NORTH: 2015 INTERNATIONAL BUILDING CODE; PRINCE GEORGE'S COUNTY ELECTRICAL CODE, SUBTITLE 9; NFPA 70, 2014 NATIONAL

ELECTRICAL CODE; 2015 INTERNATIONAL ENERGY CONSERVATION CODE. 1.4. LARGO TOWN CENTER SOUTH: 2015 INTERNATIONAL BUILDING CODE; PRINCE GEORGE'S COUNTY ELECTRICAL CODE, SUBTITLE 9; NFPA 70, 2014 NATIONAL ELECTRICAL CODE: 2015 INTERNATIONAL ENERGY CONSERVATION CODE.

1.5. WEST FALLS CHURCH: 2012 INTERNATIONAL BUILDING CODE; 2012 VIRGINA ENERGY CONSERVATION CODE; NFPA 70, 2011 NATIONAL ELECTRICAL CODE. 1.6. VIENNA NORTH: 2012 INTERNATIONAL BUILDING CODE; 2012 VIRGINA ENERGY CONSERVATION CODE; NFPA 70, 2011 NATIONAL ELECTRICAL CODE.


AND TAG-OUT PROCEDURES HAVE BEEN OBSERVED. PRIOR TO ANY DEMOLITION, OR REMOVAL OF EQUIPMENT OR DEVICES, AND THAT ALL

8. THE CONTRACTOR SHALL BE RESPONSIBLE FOR FILLING, PATCHING, THE ELECTRICAL DEMOLITION WORK. WHERE APPLICABLE THE CONTRACTOR

9. THE CONTRACTOR AND FACILITY PERSONNEL SHALL REROUTE AND/OR RECONNECT ANY ELECTRICAL CIRCUITS THAT WILL REMAIN IN USE BUT INTERFERES WITH THE NEW CONSTRUCTION. THE CONTRACTOR SHALL PERFORM A FIELD INVESTIGATION PRIOR TO CONSTRUCTION OF NEW WORK TO VERIFY THE EXTENT OF THE DEMOLITION WORK REQUIRED. ALL WIRING AND CONDUITS THAT WILL NOT BE REUSED AND WILL BE REMOVED, AFTER THE COMPLETION OF THE NEW CONSTRUCTION.

10. CONTRACTOR AND FACILITY PERSONNEL SHALL AIM TO ELIMINATE OR

LOCATIONS HAVE BEEN VERIFIED FOR CORRECTIVE WORK TO COMMENCE. 12. REFER TO ANY OTHER DISCIPLINE DRAWINGS, (CIVIL, ARCHITECTURAL,

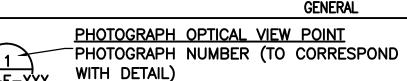

-SHEET NUMBER WHERE PHOTOGRAPH IS

-DIRECTIONAL VIEW OF PHOTOGRAPH

DEFICIENCY REFERENCE

-INDICATES DEFICIENCY NUMBER XXX-E-XXX SHEET NUMBER WHERE DETAIL/PHOTO OR ENLARGED PLAN IS DRAWN

> A Gannett Fleming/Parsons JOINT VENTURE

				REFERENCE DRAWINGS			REVISIONS	
DEGLONED	M.RICHARDS	01/2018	NUMBER	TITLE	DATE	NUM	DESCRIPTION	
DESIGNED	W.RICHARDS	DATE			01/25/2018	0	FINAL SUBMITTAL	_
DRAWN	R. PINNICK	01/2018						
Dia titit		DATE						
CHECKED	M. RICHARDS	01/2018						
		DATE						
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WASHINGTON METROPOLITAN AREA TRANSIT AUTHORITY


OFFICE OF DESIGN AND CONSTRUCTION


IRPG - FIXED FACILITIES of Monte A. Kicharde APPROVED 01/25/2018 JOHN PURDY


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ONTE A. RICHARDS, P.E.	DATE	١
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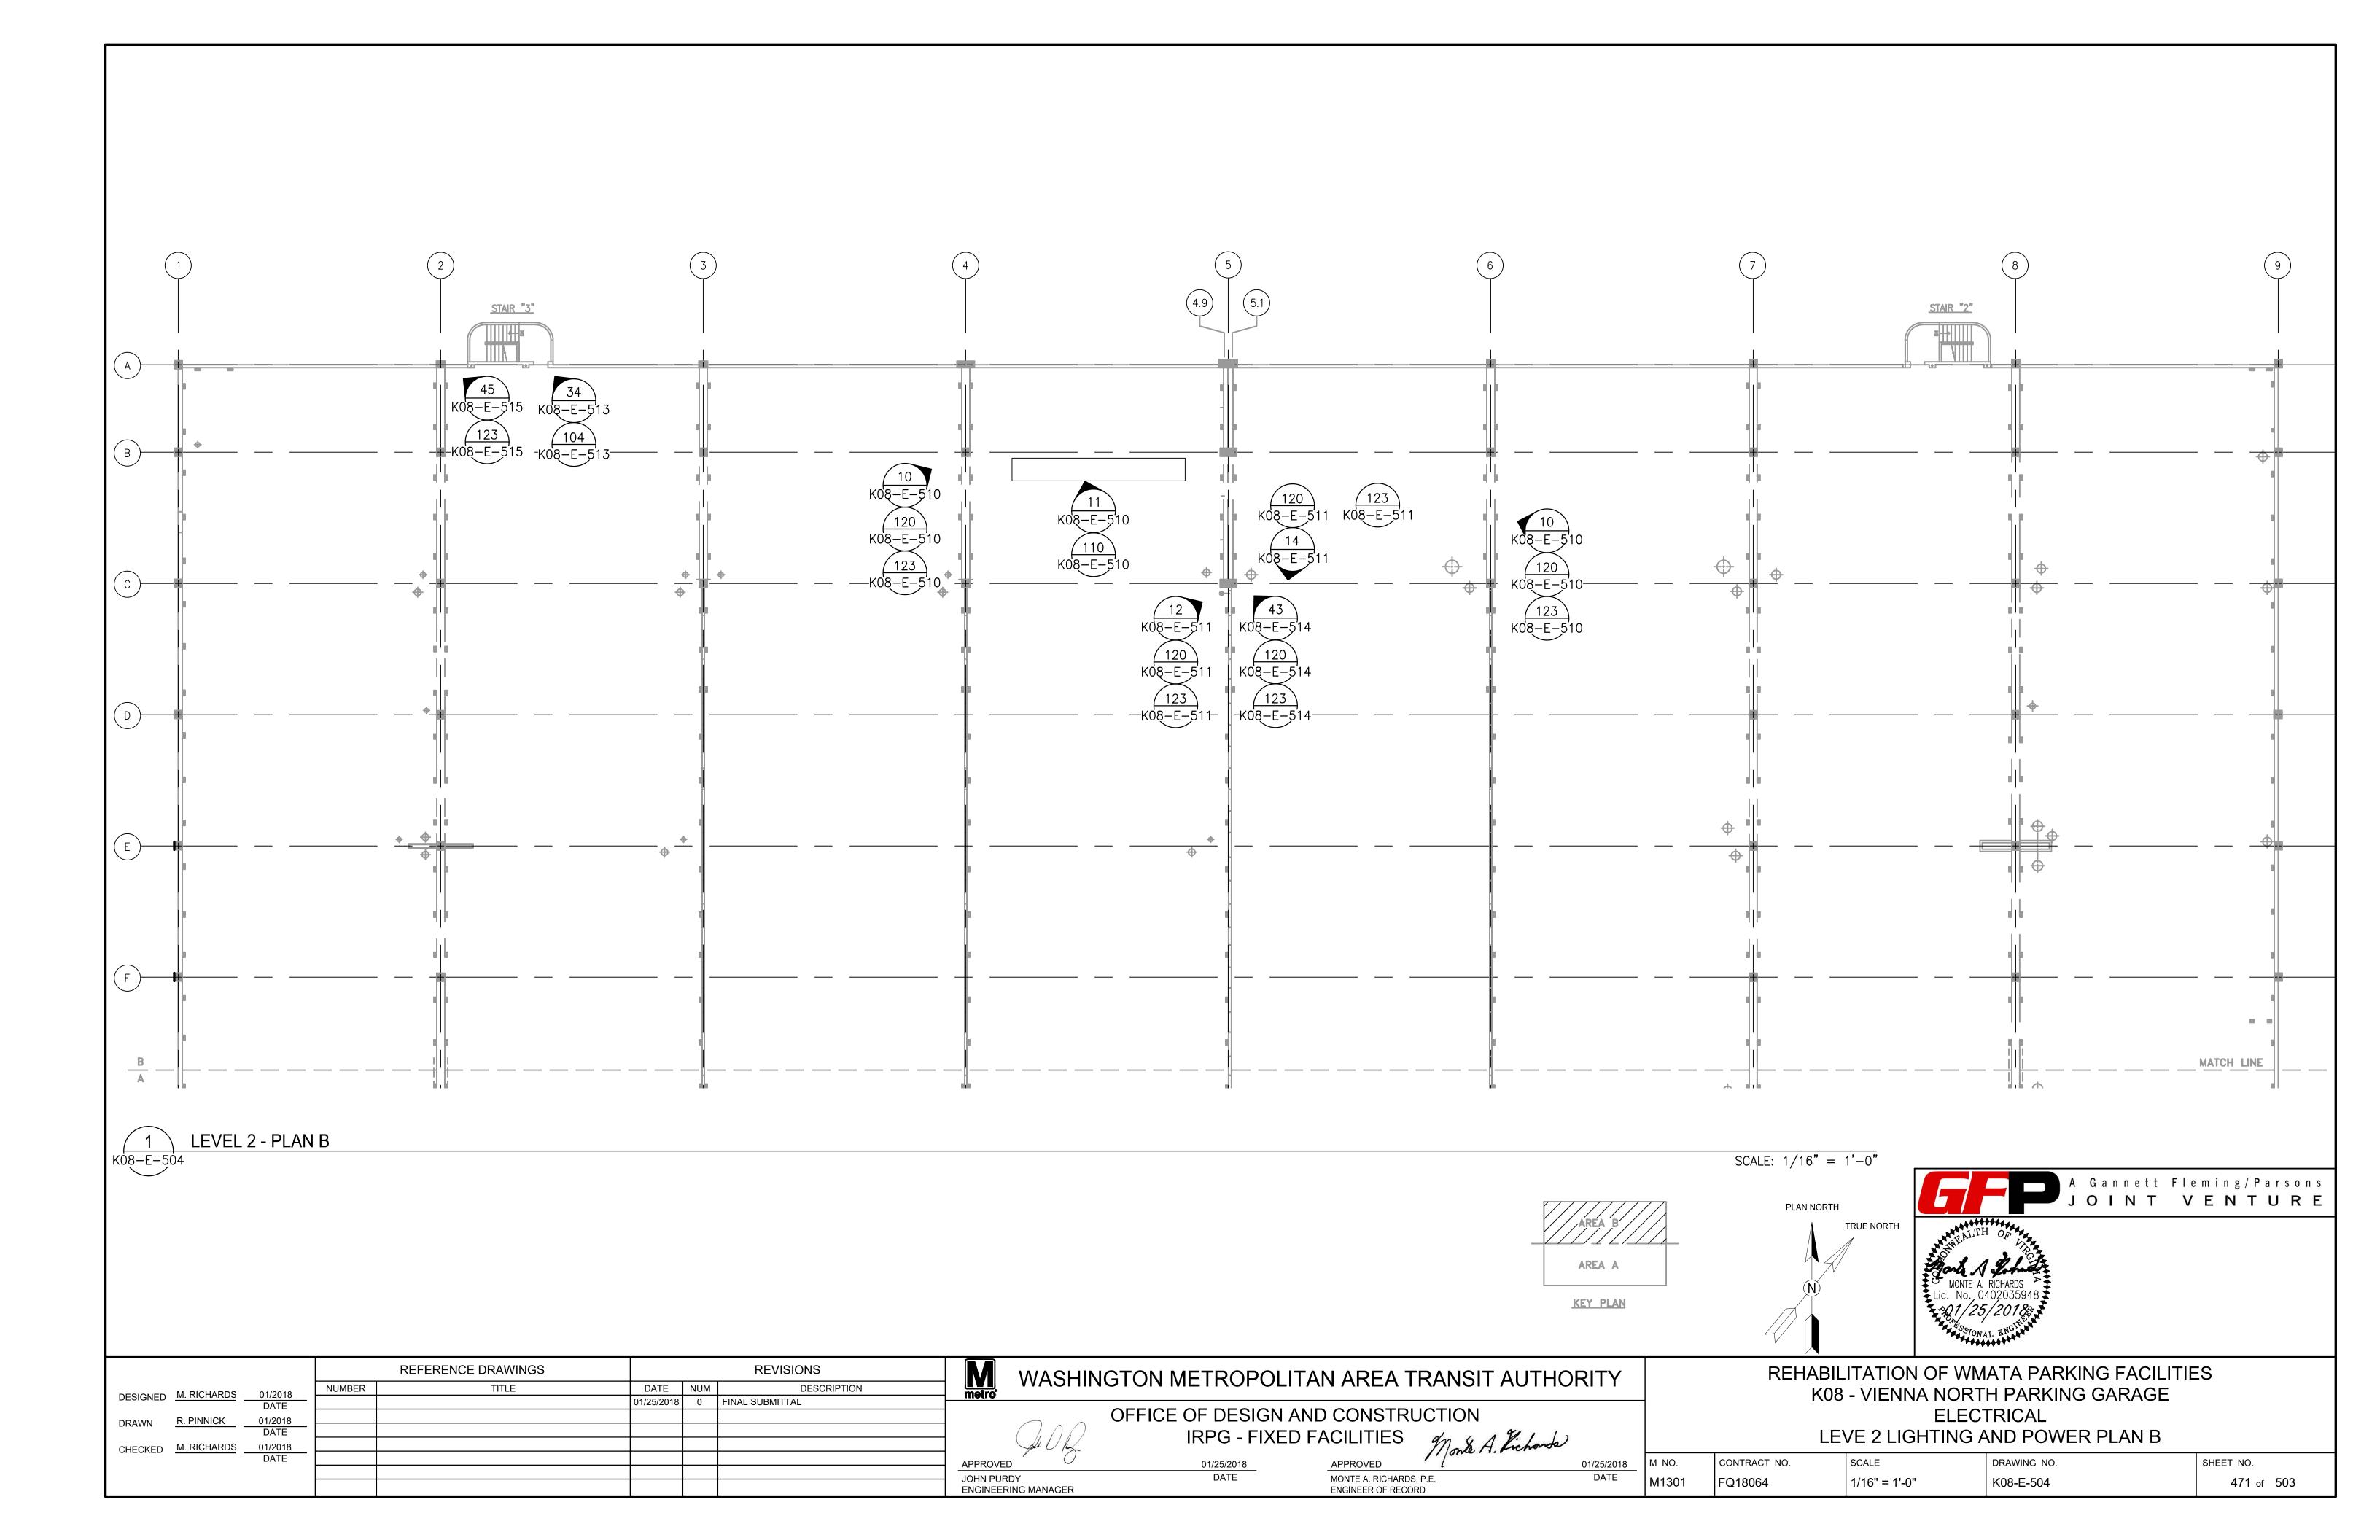
REHABILITATION OF WMATA PARKING FACILITIES K08 - VIENNA NORTH PARKING GARAGE ELECTRICAL GENERAL NOTES ARREVIATIONS AND SYMBOLS


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M NO.	CONTRACT NO.	SCALE	DRAWING NO.	SHEET NO.
M1301	FQ18064	NONE	K08-E-001	467 of 503




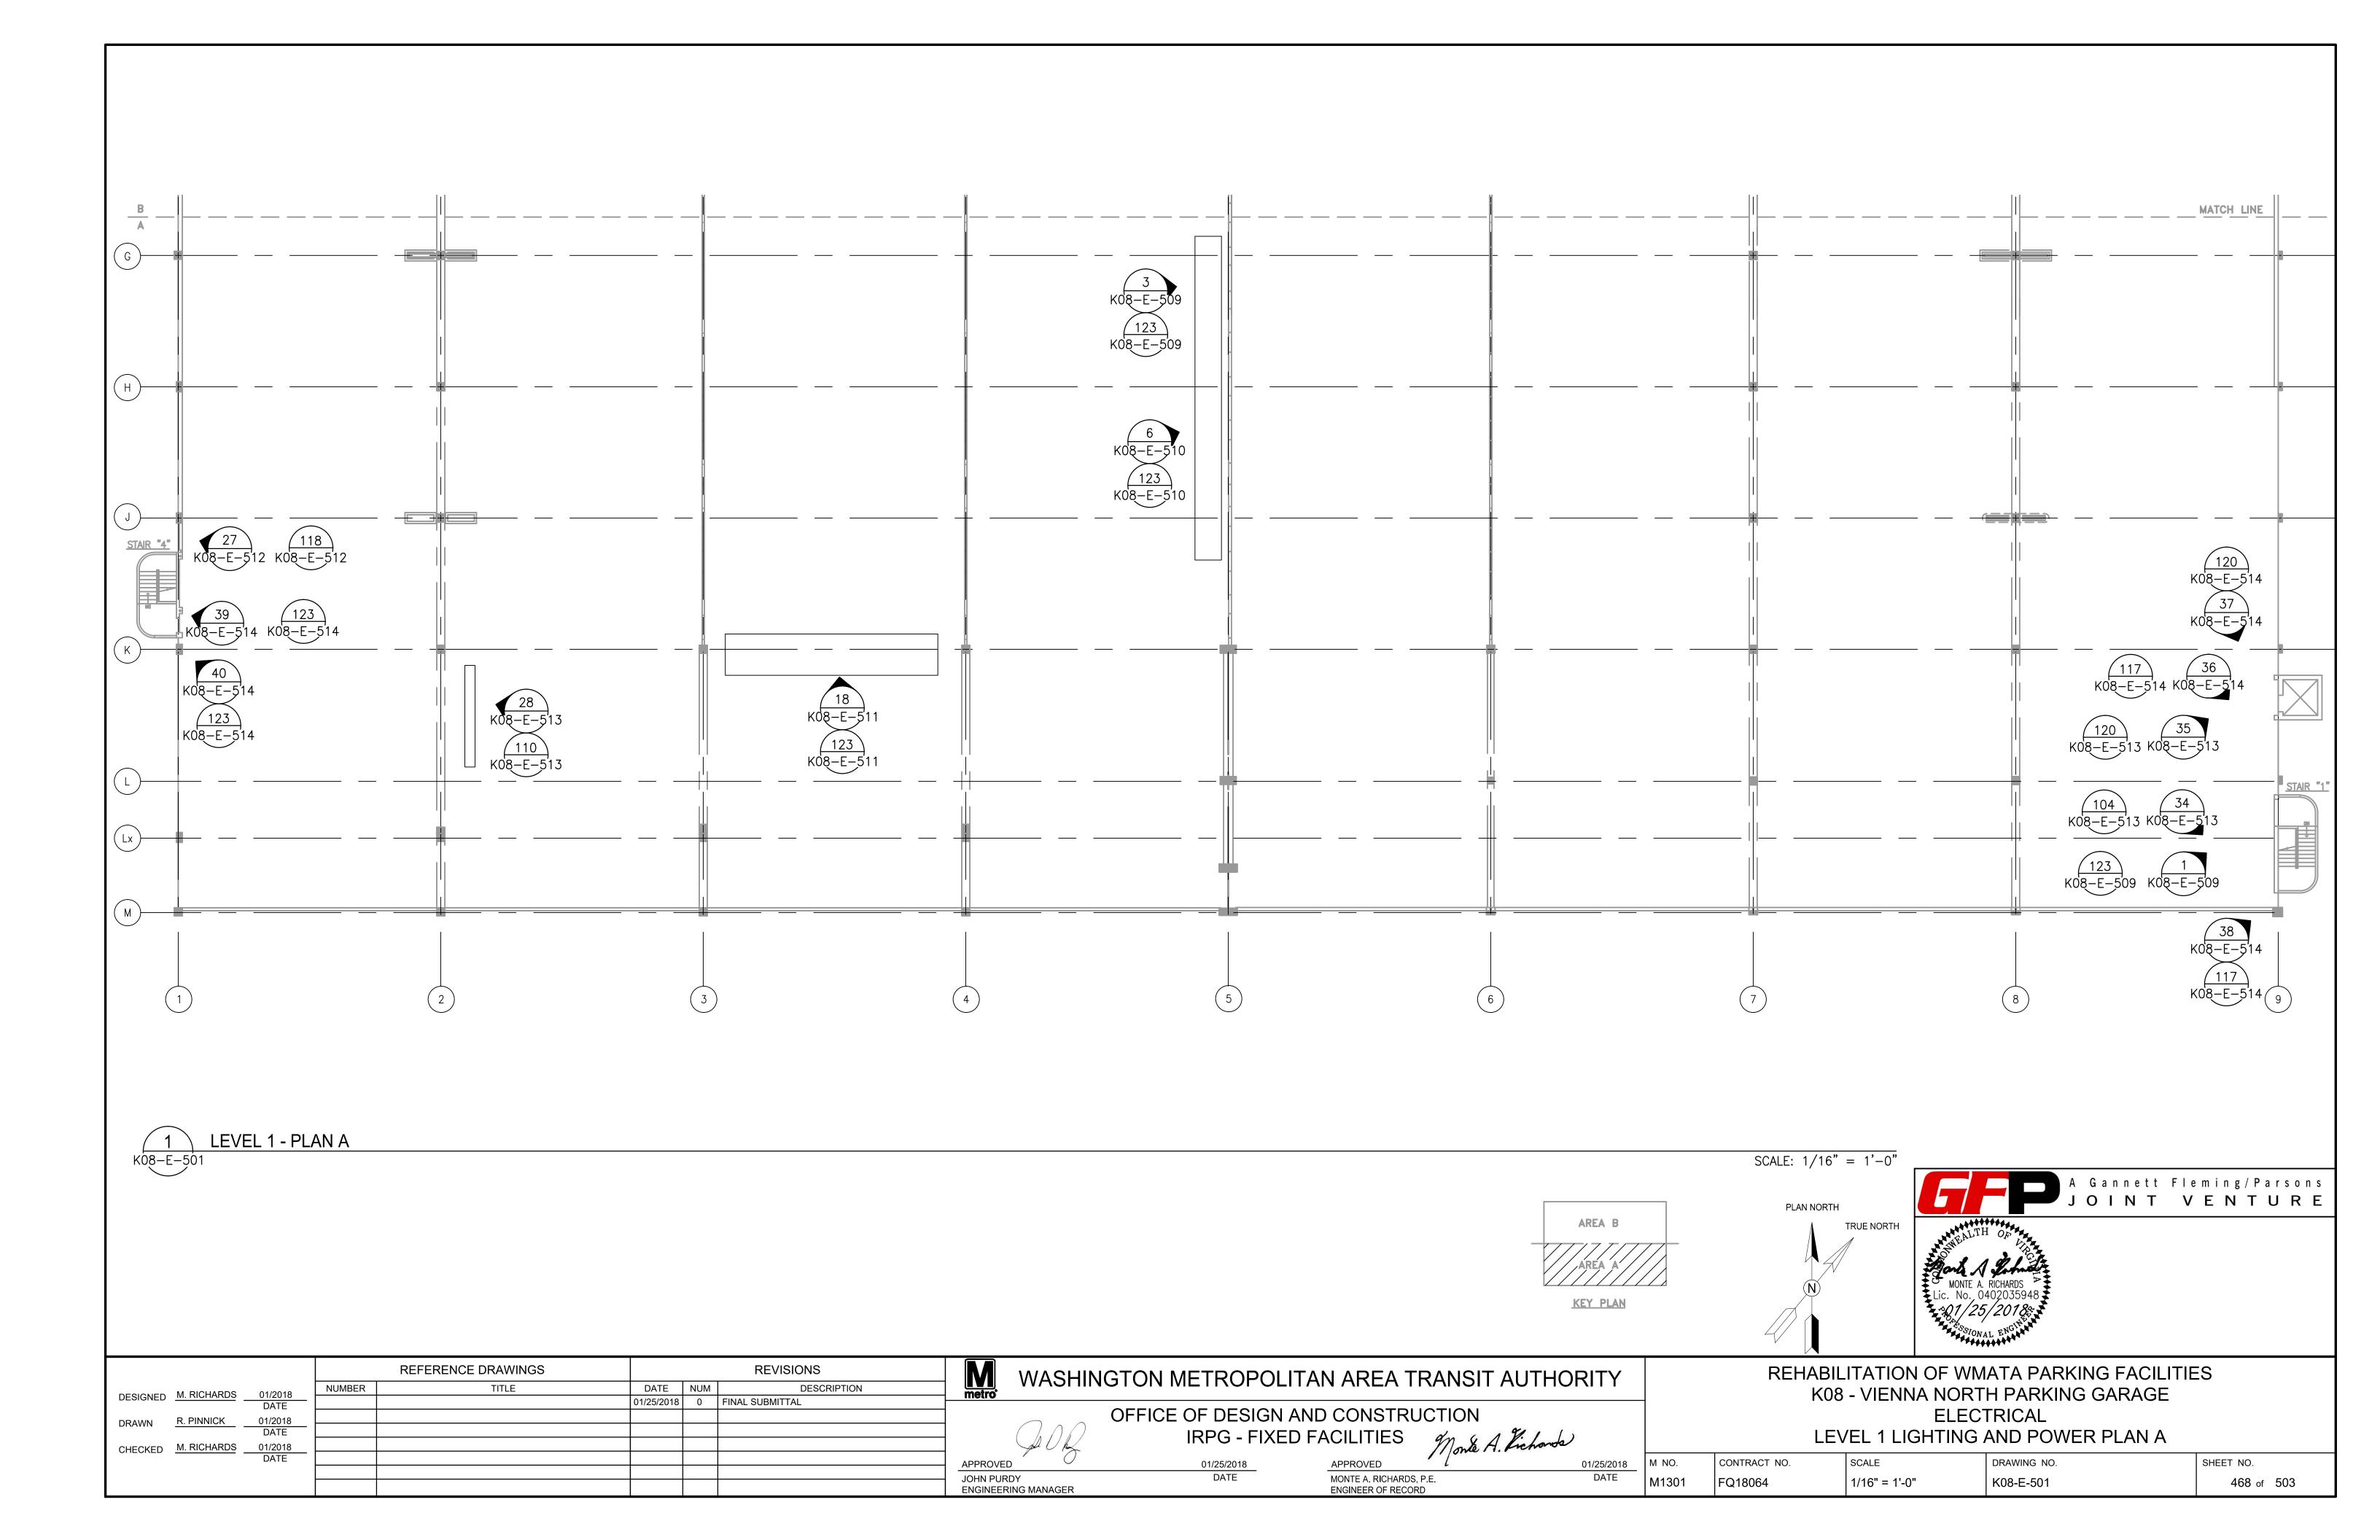


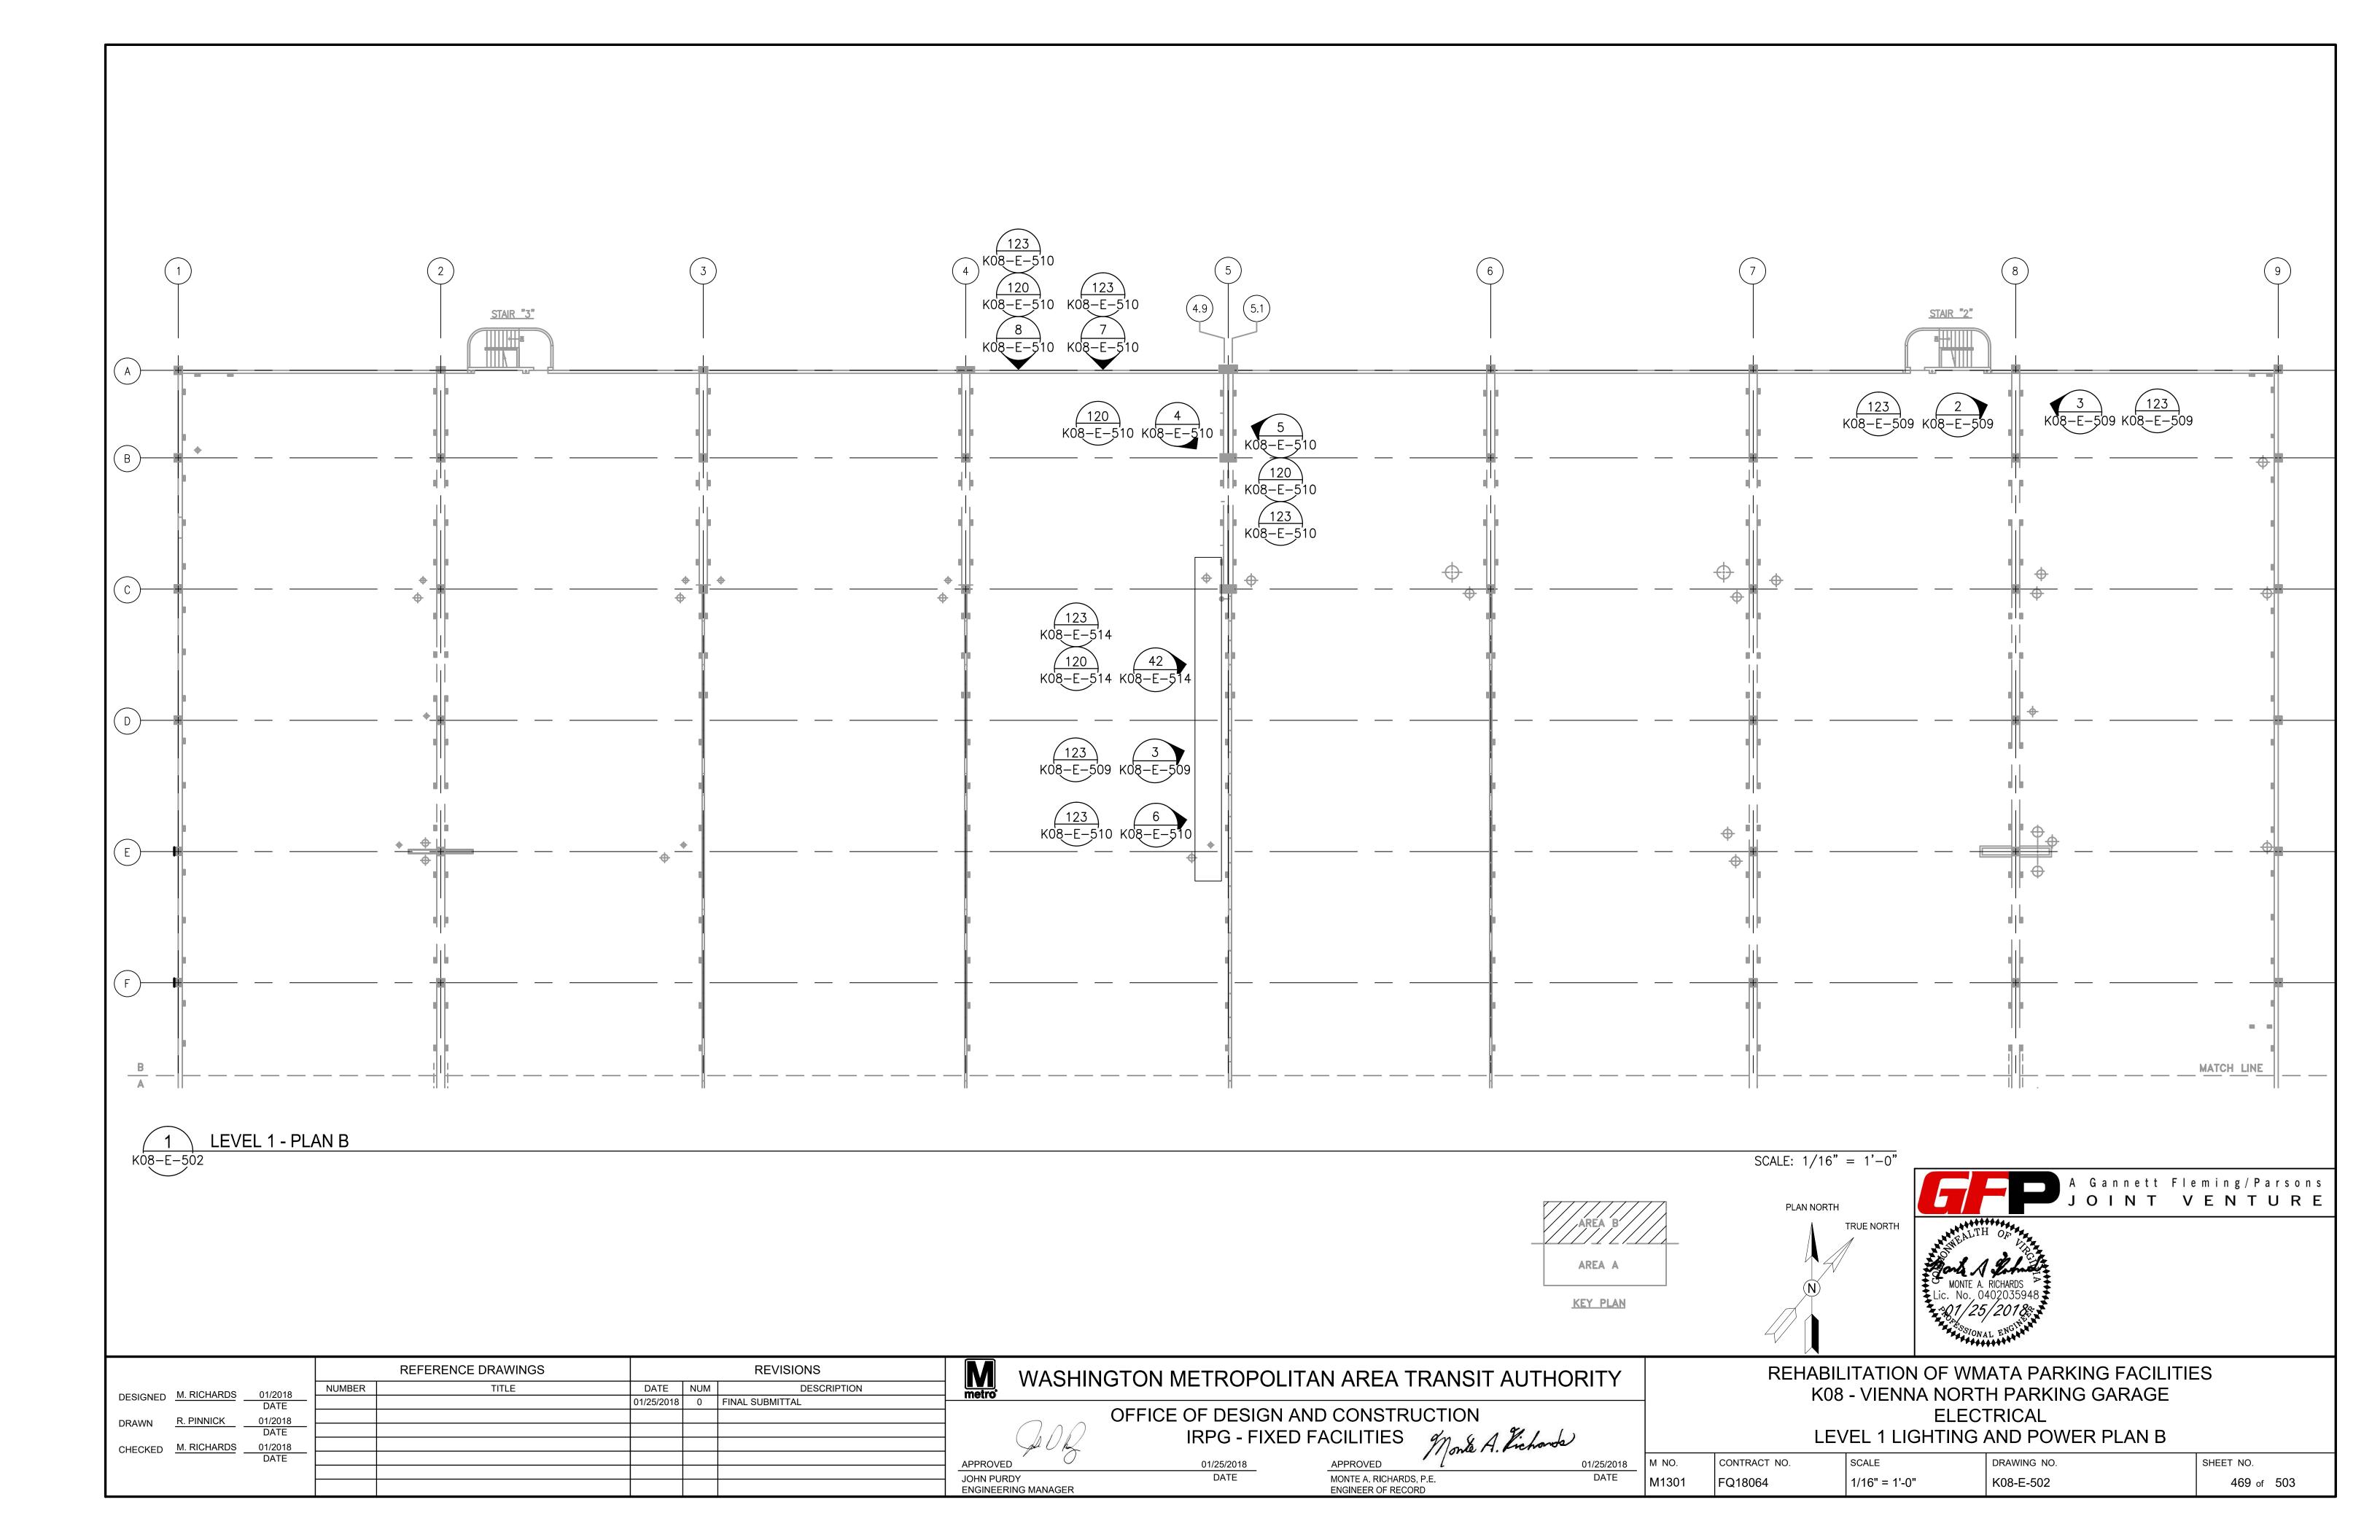


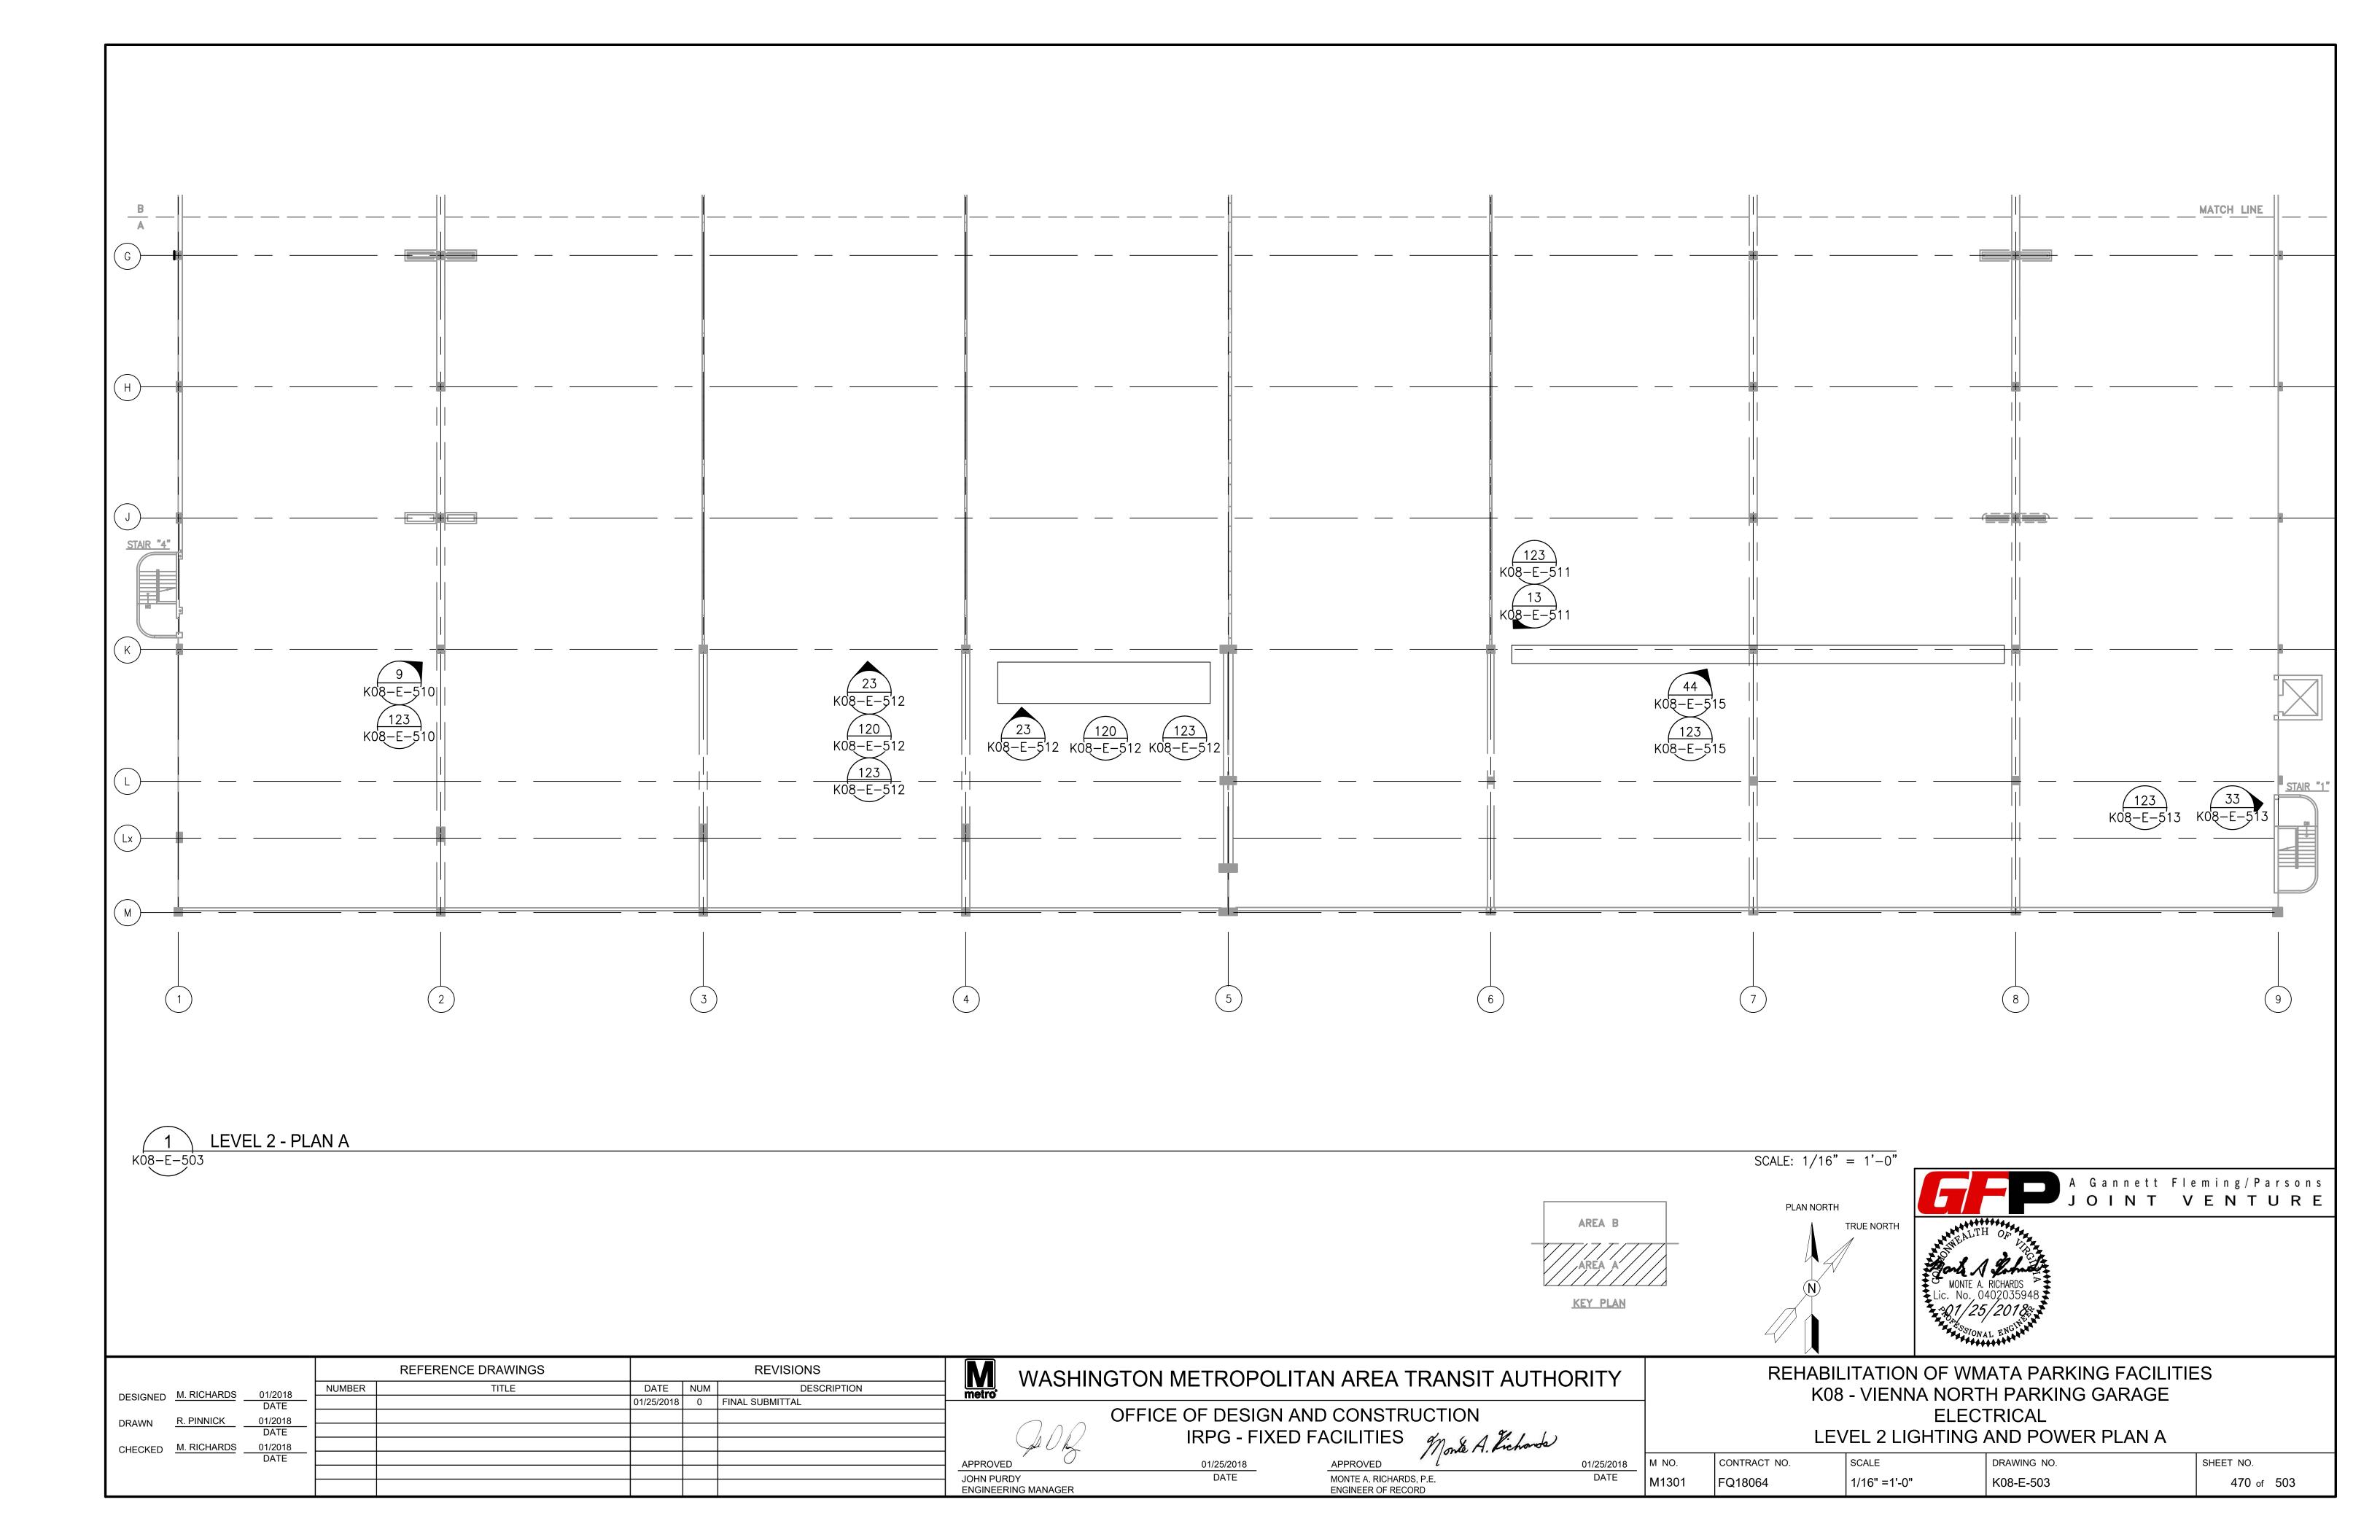

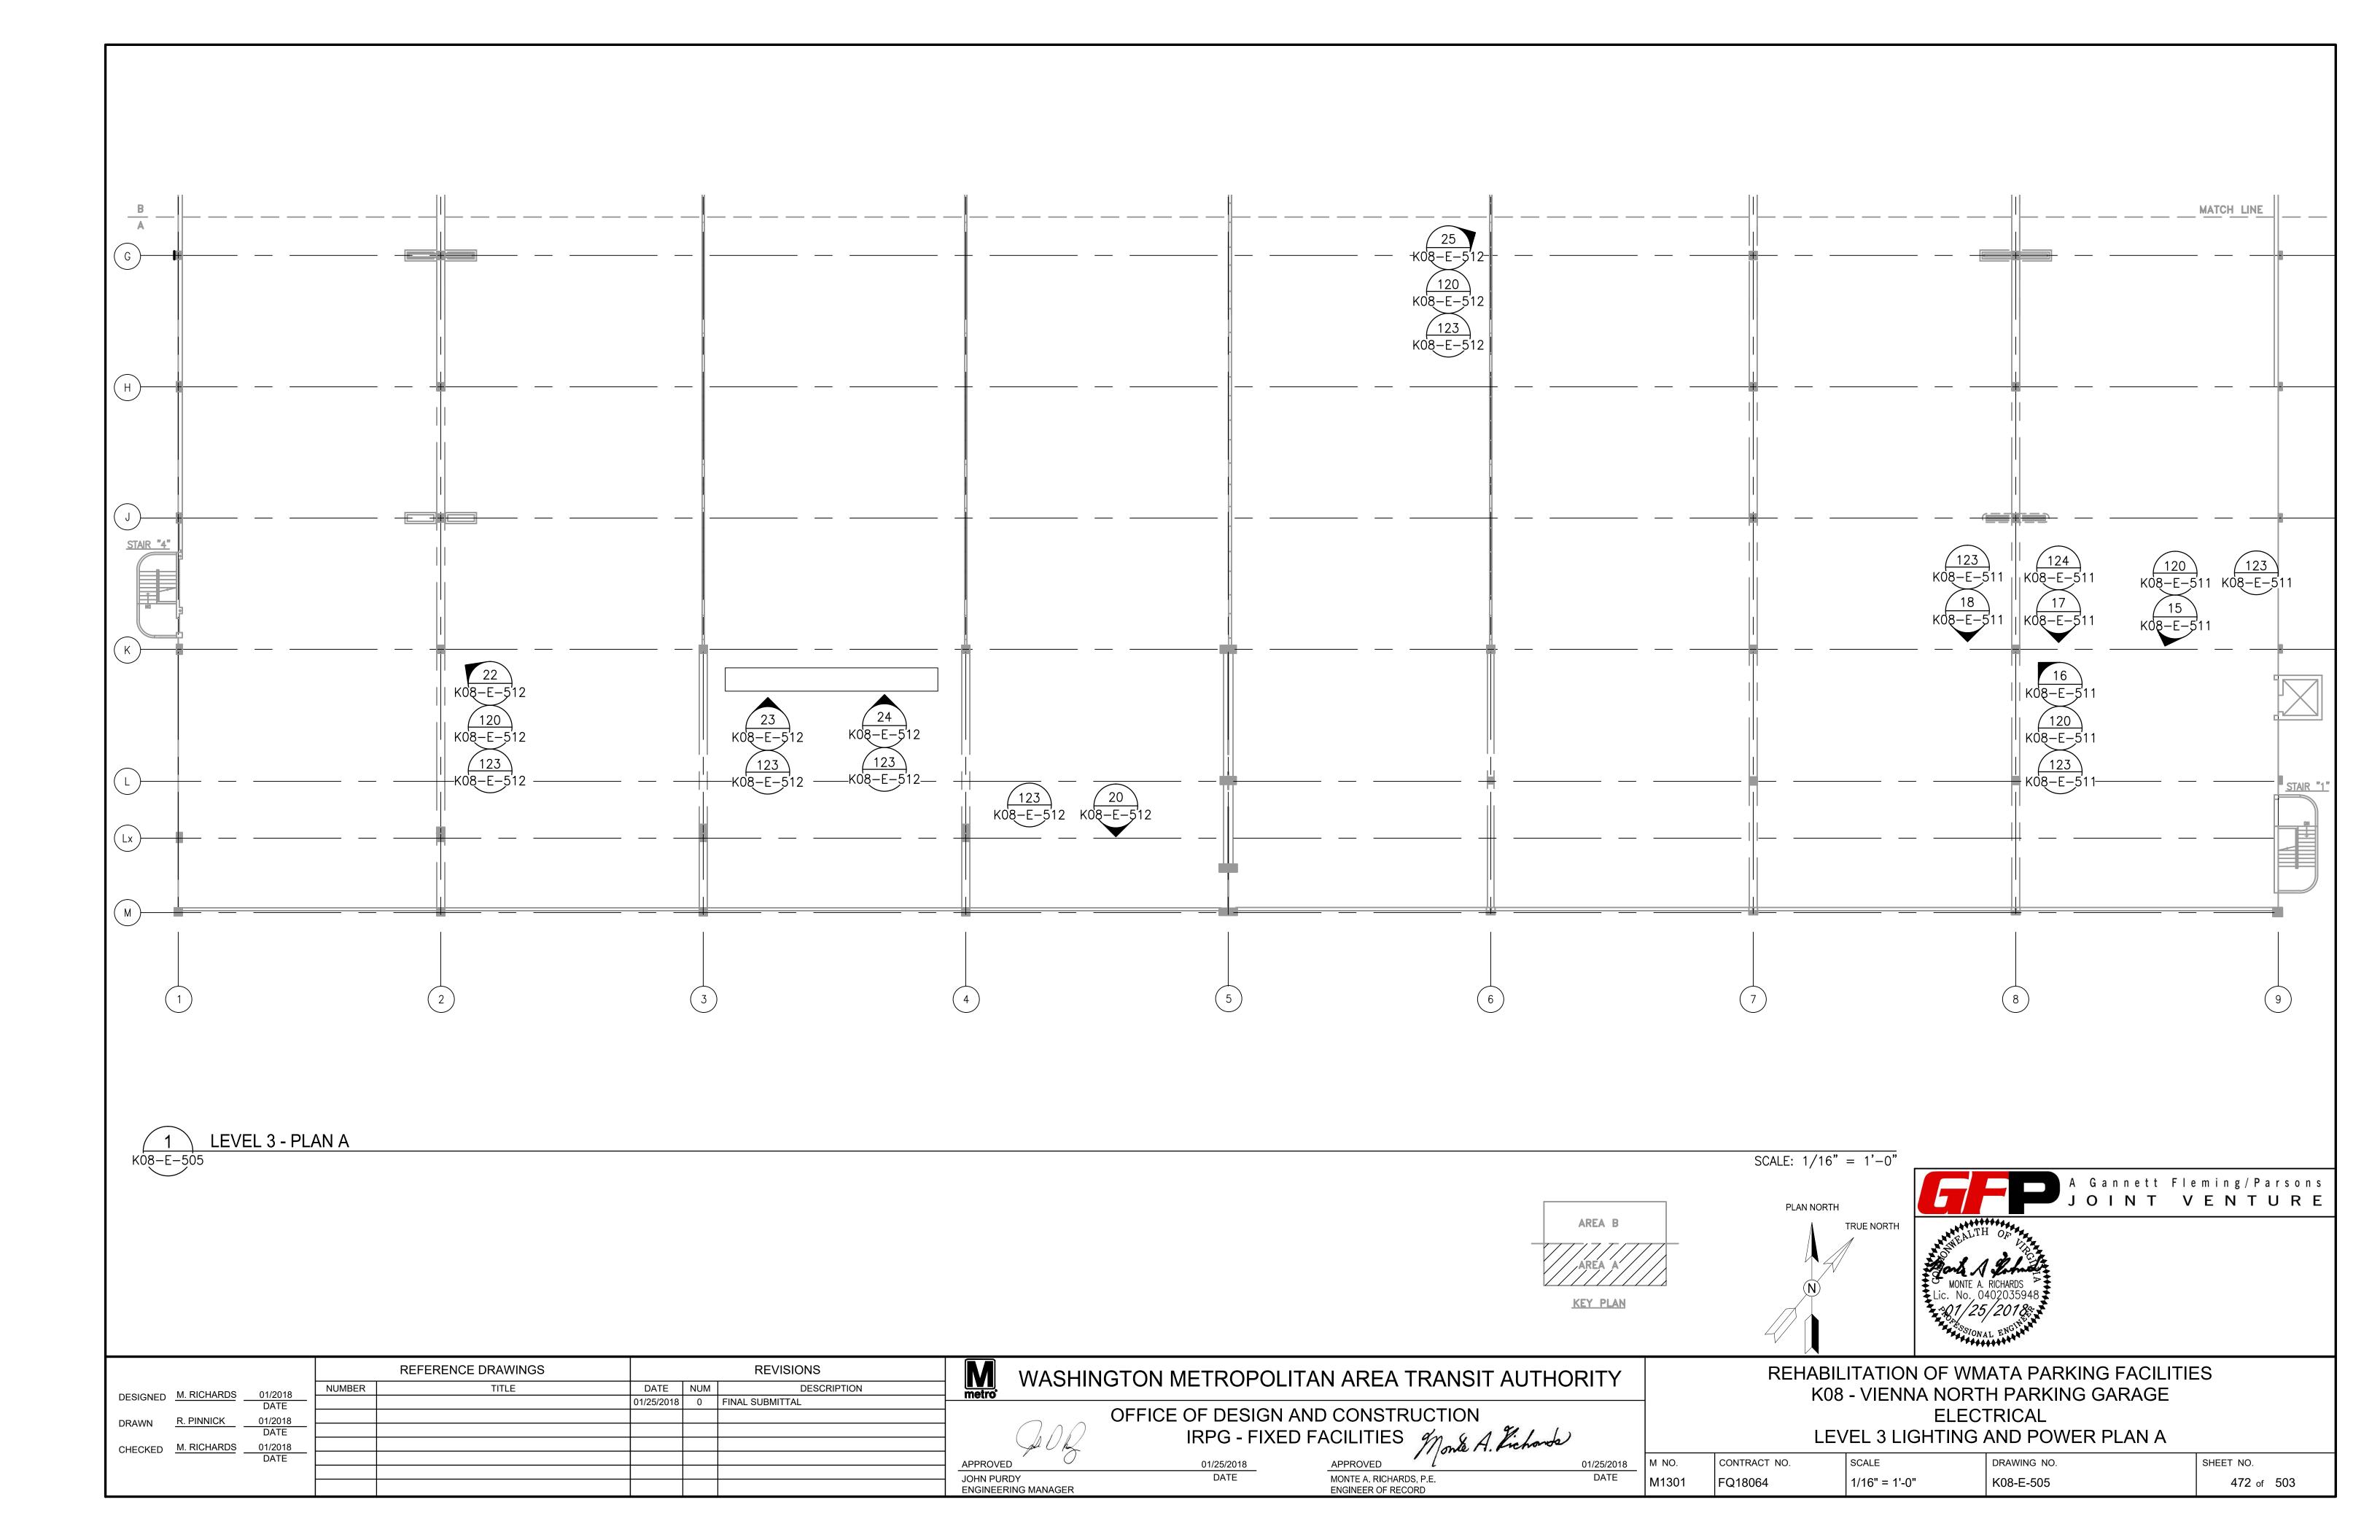

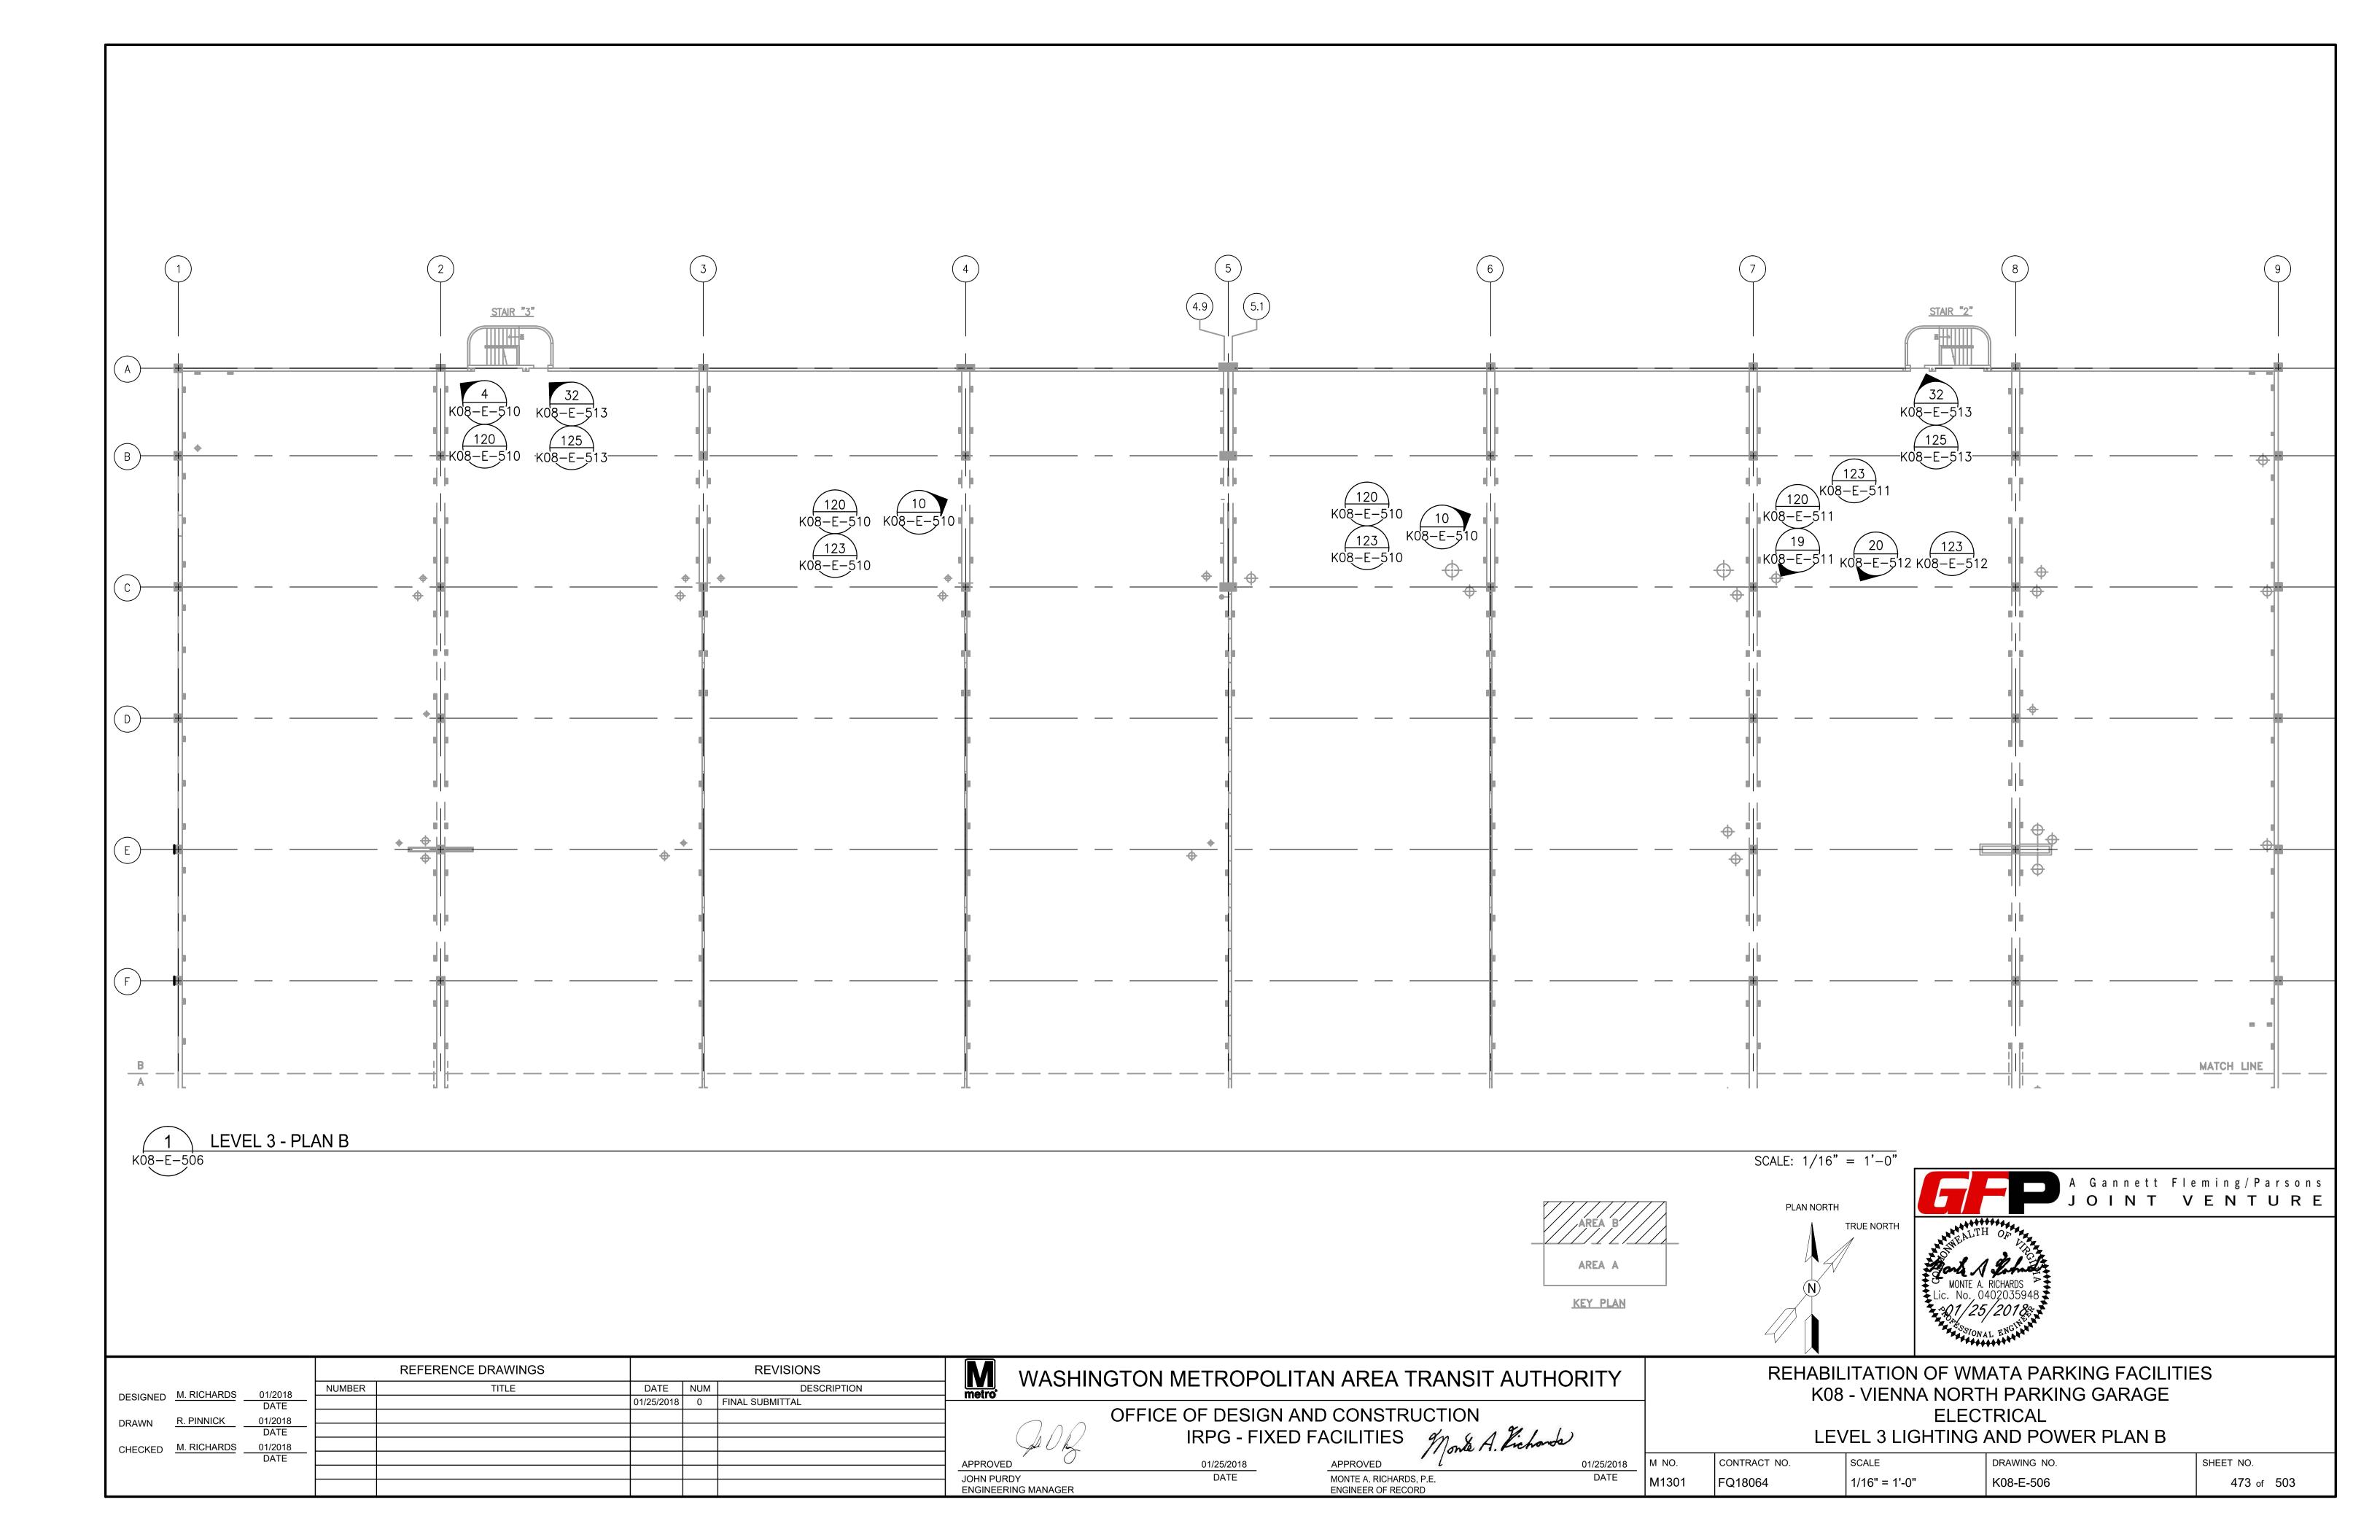

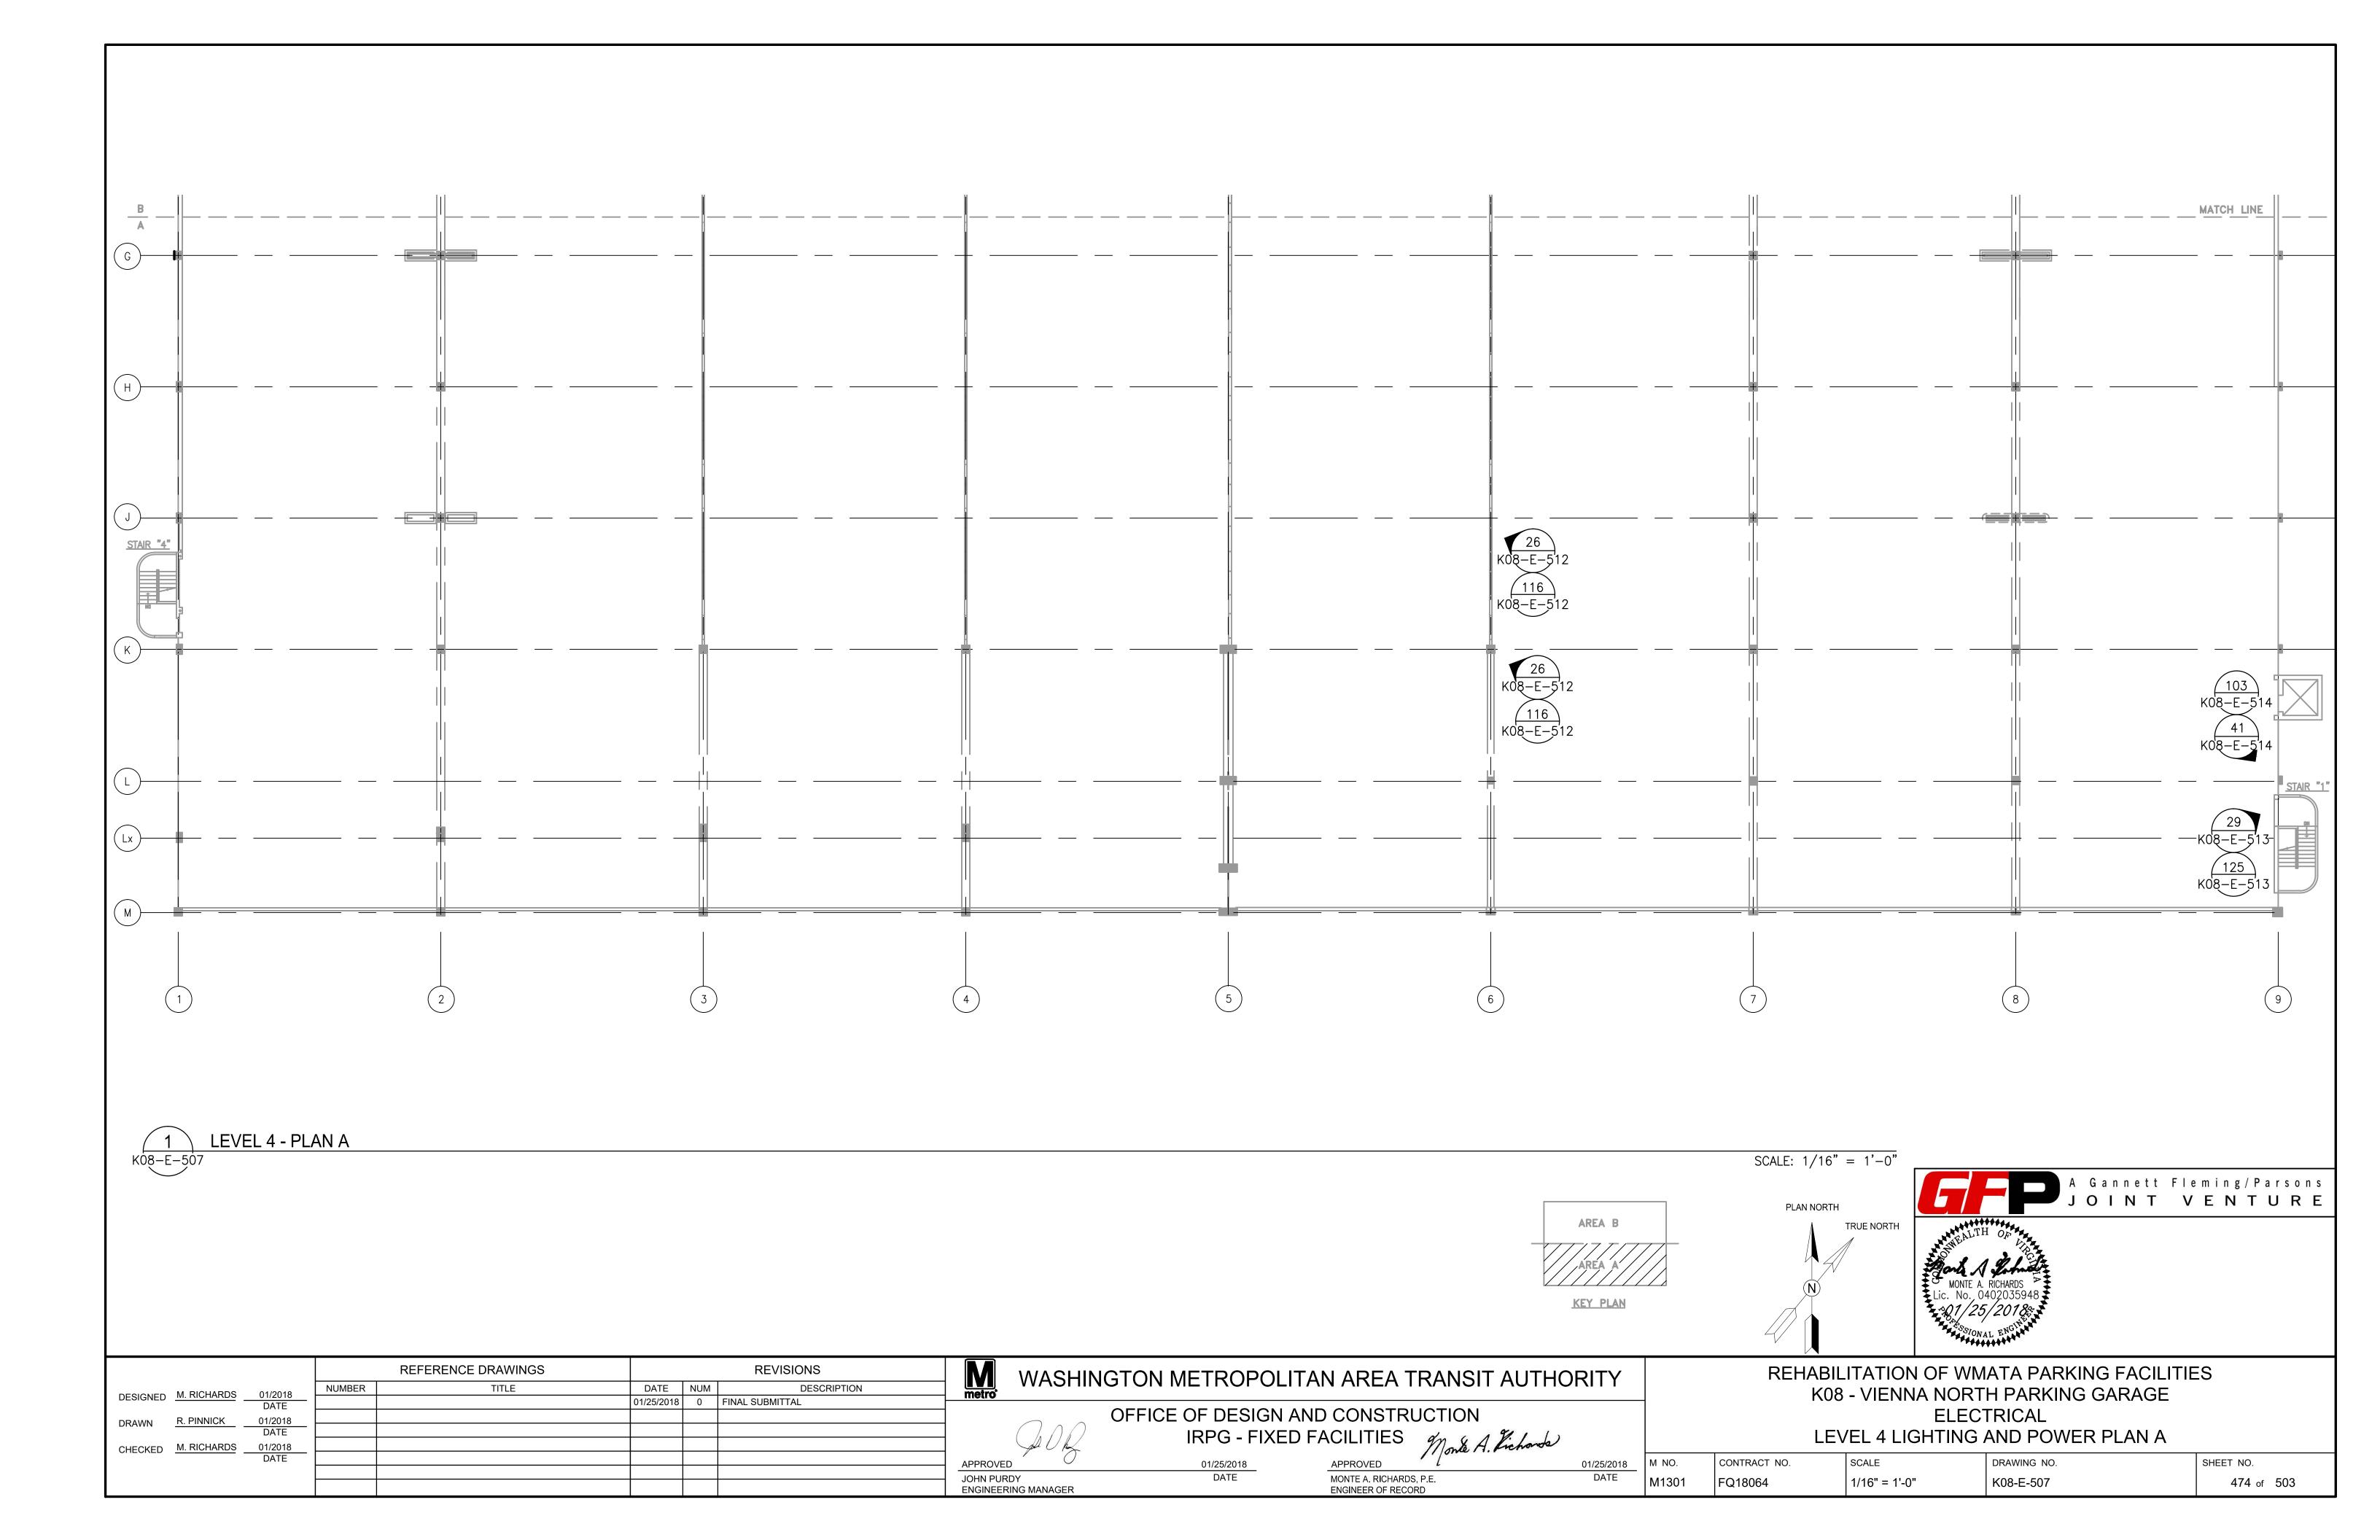

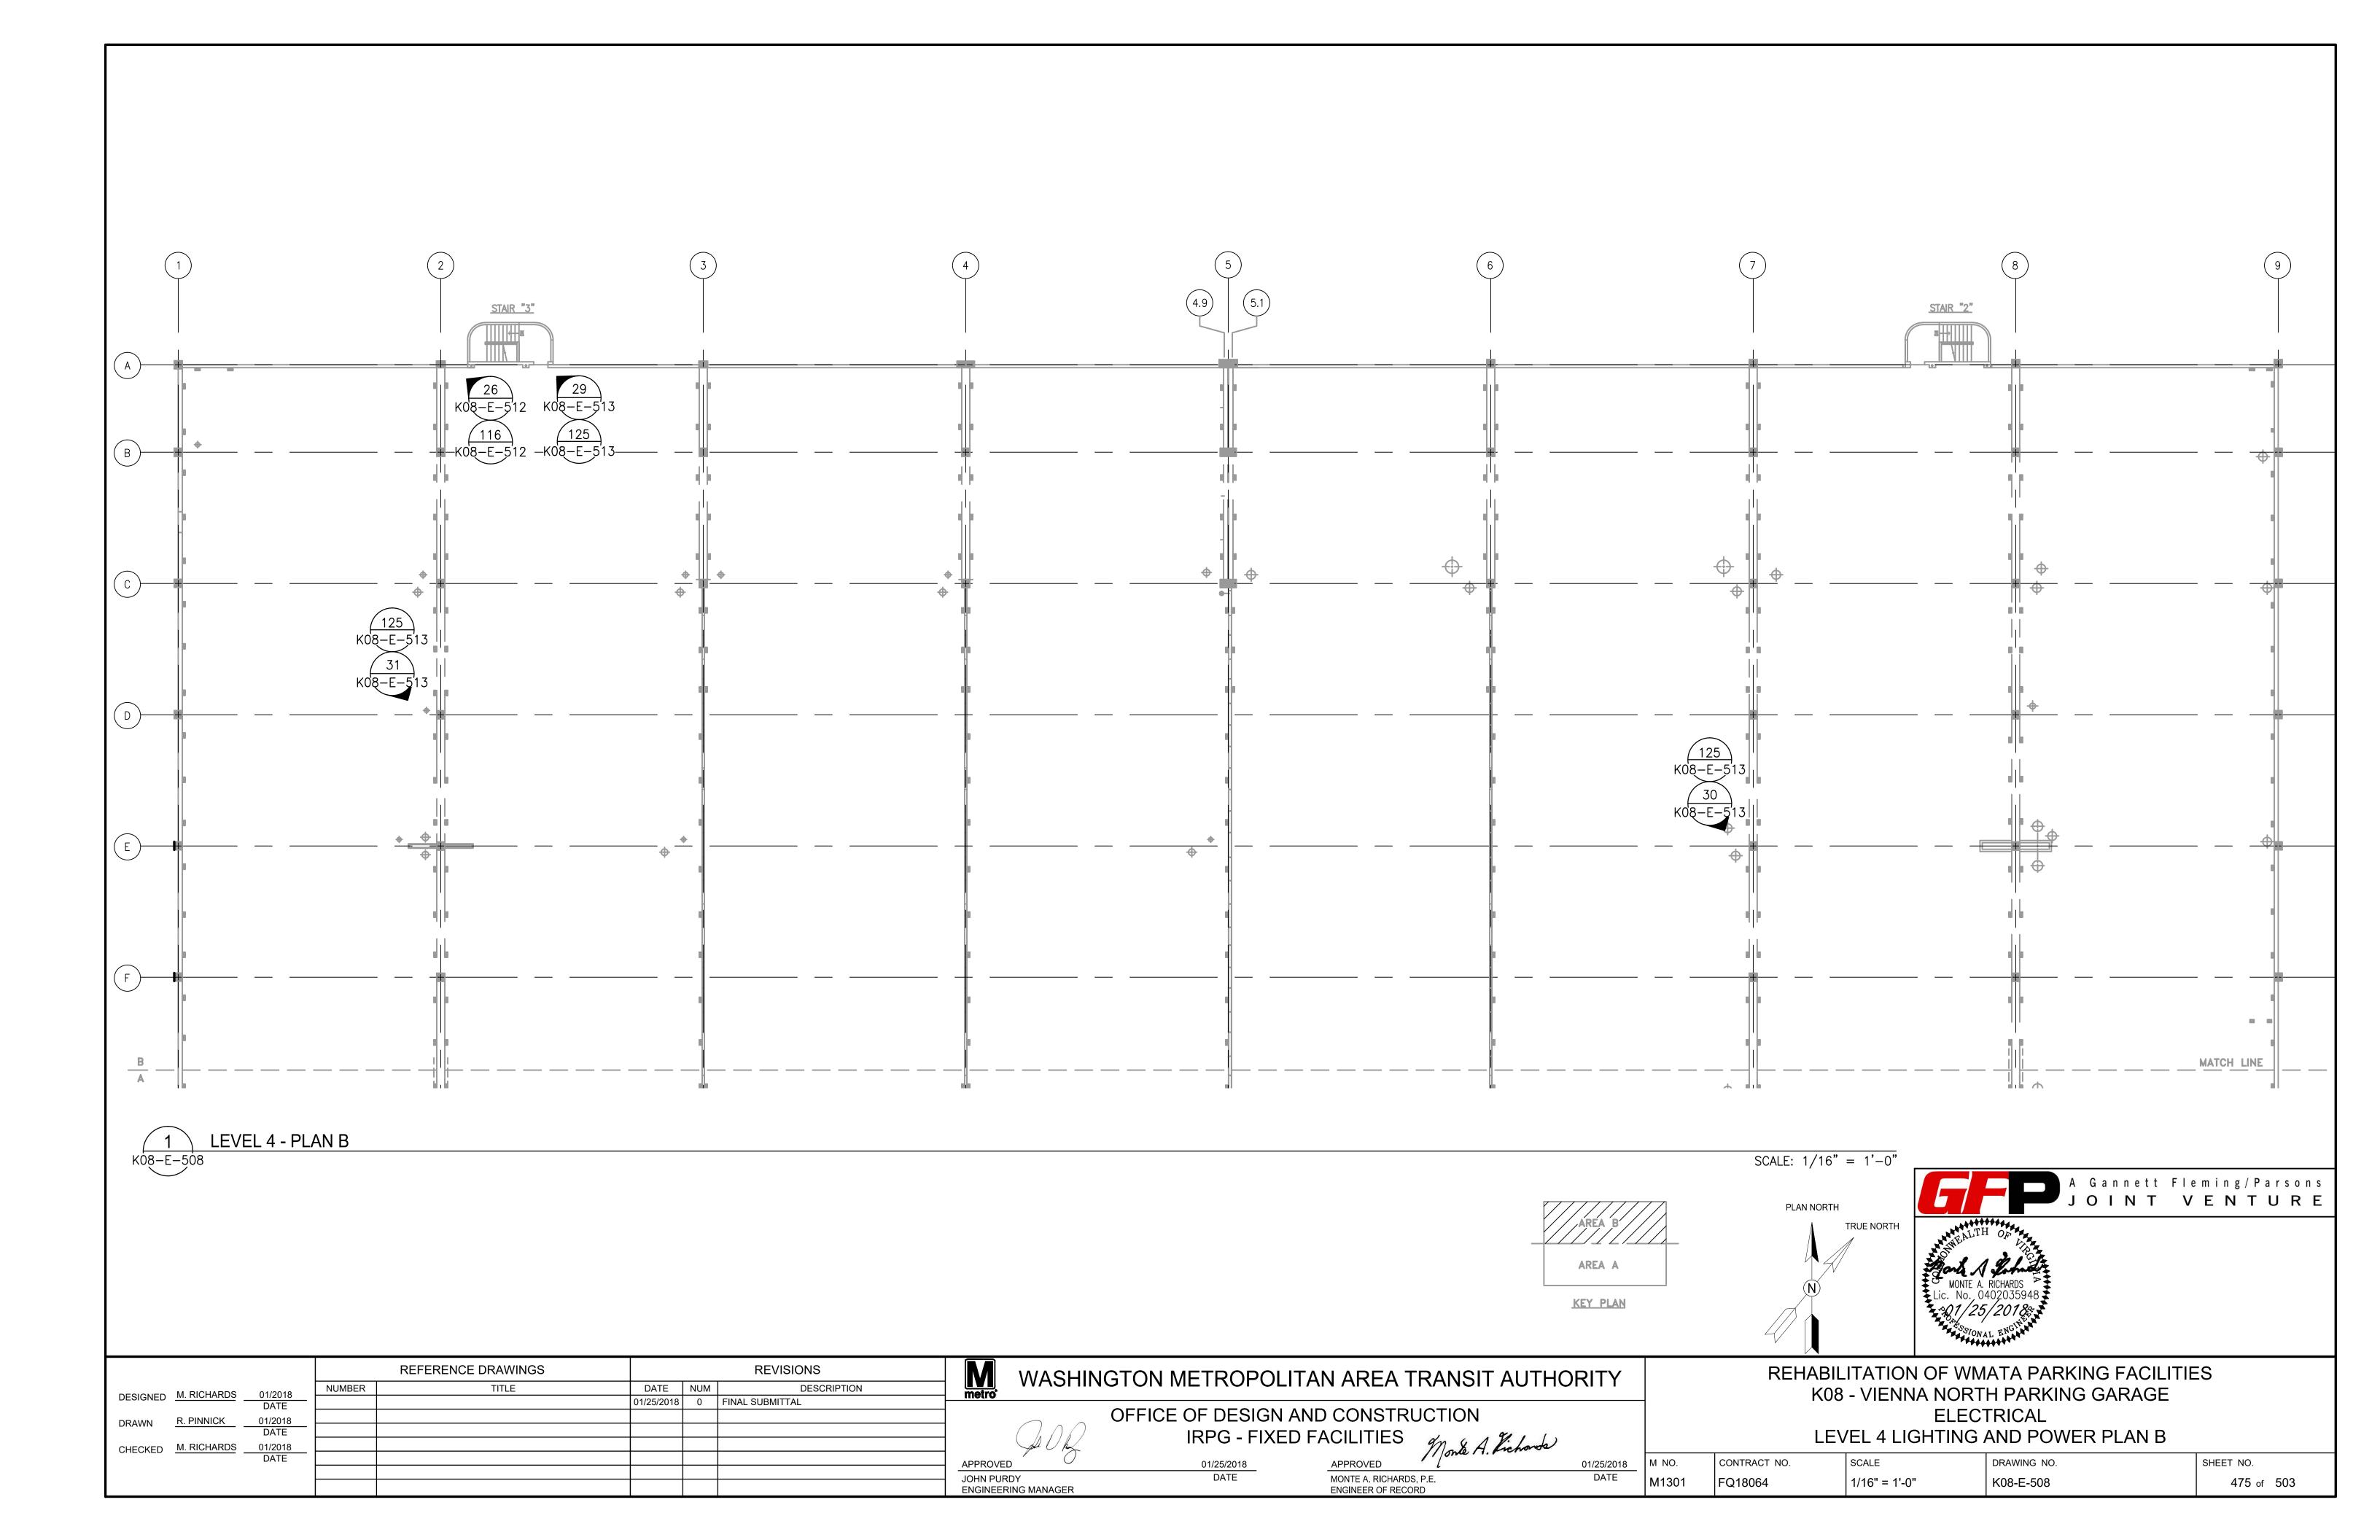

1		T	<u> </u>		RY OF ELECTRICAL DEFICIENCIES TABLE - VIENNA NORTH GARAGE	 	
EM No.	LOCATION	DEFICIENCY DESCRIPTION	PHOTO No.	CORRECTIVE ACTION No.	REPAIR DESCRIPTION	UNIT OF QTY.	NO. OF LOCATIOI
1	LEVEL 1	CORRODED CONDUIT SUPPORT	V1	123	REMOVE & REPLACE SUPPORTING STRAPS AND MOUNTING SUPPORTS WITH ANODIZED ALUMINUM COMPONENTS. REMOVE RUST WITH A WIRE BRUSH, SANDPAPER, ETC. PAINT EXTERIOR METAL COMPONENTS WITH A CORROSION-RESISTANT PRIMER. APPLY MATCHING FINISH COAT APPROVED FOR USE.	EACH	1
2	LEVEL 1	CORRODED CONDUIT SUPPORT	V2	123	REMOVE & REPLACE SUPPORTING STRAPS AND MOUNTING SUPPORTS WITH ANODIZED ALUMINUM COMPONENTS. REMOVE RUST WITH A WIRE BRUSH, SANDPAPER, ETC. PAINT EXTERIOR METAL COMPONENTS WITH A CORROSION-RESISTANT PRIMER. APPLY MATCHING FINISH COAT APPROVED FOR USE.	EACH	1
3	LEVEL 1	CORRODED CONDUIT SUPPORT	V3	123	REMOVE & REPLACE SUPPORTING STRAPS AND MOUNTING SUPPORTS WITH ANODIZED ALUMINUM COMPONENTS. REMOVE RUST WITH A WIRE BRUSH, SANDPAPER, ETC. PAINT EXTERIOR METAL COMPONENTS WITH A CORROSION-RESISTANT PRIMER. APPLY MATCHING FINISH COAT APPROVED FOR USE.	EACH	MULTIP
4	LEVEL 1 & 3	CORRODED CONDUIT	V4	120	LOCK OUT BREAKER, TAG, IDENTIFY, AND REMOVE CONDUCTORS TO THE NEAREST UNDAMAGED JUNCTION BOX OR POINT OF TERMINATION. CUT AND/OR REMOVE THE CORRODED CONDUIT BODY AND/OR PORTION OF CORRODED CONDUIT AND SUPPORTS. RE-THREAD AND REASSEMBLE. RECONNECT CONDUCTORS. CLOSE BREAKER AND TEST TO CONFIRM CABLE INSULATION INTEGRITY AND PROPER VOLTAGE. REPLACE CABLING, IF NECESSARY.	EACH	1
5	LEVEL 1	CORRODED CONDUIT & J-BOX	V5	120/123	REMOVE & REPLACE SUPPORTING STRAPS AND MOUNTING SUPPORTS WITH ANODIZED ALUMINUM COMPONENTS. REMOVE RUST WITH A WIRE BRUSH, SANDPAPER, ETC. PAINT EXTERIOR METAL COMPONENTS WITH A CORROSION-RESISTANT PRIMER. APPLY MATCHING FINISH COAT APPROVED FOR USE. REPLACE J-BOX COVER AND GASKET.	EACH	2
6	LEVEL 1	CORRODED CONDUIT SUPPORT	V6	123	REMOVE & REPLACE SUPPORTING STRAPS AND MOUNTING SUPPORTS WITH ANODIZED ALUMINUM COMPONENTS. REMOVE RUST WITH A WIRE BRUSH, SANDPAPER, ETC. PAINT EXTERIOR METAL COMPONENTS WITH A CORROSION-RESISTANT PRIMER. APPLY MATCHING FINISH COAT APPROVED FOR USE.	EACH	MULTIF
7	LEVEL 1	CORRODED J-BOX	V7	123	REMOVE & REPLACE SUPPORTING STRAPS AND MOUNTING SUPPORTS WITH ANODIZED ALUMINUM COMPONENTS. REMOVE RUST WITH A WIRE BRUSH, SANDPAPER, ETC. PAINT EXTERIOR METAL COMPONENTS WITH A CORROSION-RESISTANT PRIMER. APPLY MATCHING FINISH COAT APPROVED FOR USE. REPLACE J-BOX COVER AND GASKET.	EACH	1
8	LEVEL 1	CORRODED CONDUIT COUPLING	V8	120/123	LOCK OUT BREAKER, TAG, IDENTIFY, AND REMOVE CONDUCTORS TO THE NEAREST UNDAMAGED JUNCTION BOX OR POINT OF TERMINATION. CUT AND/OR REMOVE THE CORRODED CONDUIT BODY AND/OR PORTION OF CORRODED CONDUIT AND SUPPORTS. RE-THREAD AND REASSEMBLE. RECONNECT CONDUCTORS. CLOSE BREAKER AND TEST TO CONFIRM CABLE INSULATION INTEGRITY AND PROPER VOLTAGE. REPLACE CABLING, IF NECESSARY.	EACH	MULTIF
9	LEVEL 2	CORRODED CONDUIT SUPPORT	V9	123	REMOVE & REPLACE SUPPORTING STRAPS AND MOUNTING SUPPORTS WITH ANODIZED ALUMINUM COMPONENTS. REMOVE RUST WITH A WIRE BRUSH, SANDPAPER, ETC. PAINT EXTERIOR METAL COMPONENTS WITH A CORROSION-RESISTANT PRIMER. APPLY MATCHING FINISH COAT APPROVED FOR USE.	EACH	1
10	LEVEL 2	CORRODED CONDUIT & SUPPORT	V10	120/123	LOCK OUT BREAKER, TAG, IDENTIFY, AND REMOVE CONDUCTORS TO THE NEAREST UNDAMAGED JUNCTION BOX OR POINT OF TERMINATION. CUT AND/OR REMOVE THE CORRODED CONDUIT BODY AND/OR PORTION OF CORRODED CONDUIT AND SUPPORTS. RE-THREAD AND REASSEMBLE. RECONNECT CONDUCTORS. CLOSE BREAKER AND TEST TO CONFIRM CABLE INSULATION INTEGRITY AND PROPER VOLTAGE. REPLACE CABLING, IF NECESSARY.	EACH	2
11	LEVEL 2	LIGHTS NOT ILLUMINATED (DIRECTIONAL)	V11	110	VERIFY CIRCUIT IS ENERGIZED AT THE PROPER VOLTAGE. IF ELECTRICAL POWER IS PRESENT, LOCK OUT BREAKER, IDENTIFY, TAG, AND DISCONNECT THE CONDUCTORS FROM THE DEFECTIVE DEVICE. REMOVE THE DEFECTIVE DEVICE AND REPLACE IN KIND. CLOSE BREAKER AND TEST TO CONFIRM CABLE INSULATION INTEGRITY AND PROPER VOLTAGE.	EACH	4
12	LEVEL 2	CORRODED CONDUIT & J-BOX	V12	120/123	REMOVE & REPLACE SUPPORTING STRAPS AND MOUNTING SUPPORTS WITH ANODIZED ALUMINUM COMPONENTS. REMOVE RUST WITH A WIRE BRUSH, SANDPAPER, ETC. PAINT EXTERIOR METAL COMPONENTS WITH A CORROSION-RESISTANT PRIMER. APPLY MATCHING FINISH COAT APPROVED FOR USE. REPLACE J-BOX COVER AND GASKET.	EACH	1
13	LEVEL 2	CORRODED CONDUIT SUPPORT	V13	123	REMOVE & REPLACE SUPPORTING STRAPS AND MOUNTING SUPPORTS WITH ANODIZED ALUMINUM COMPONENTS. REMOVE RUST WITH A WIRE BRUSH, SANDPAPER, ETC. PAINT EXTERIOR METAL COMPONENTS WITH A CORROSION-RESISTANT PRIMER. APPLY MATCHING FINISH COAT APPROVED FOR USE.	EACH	1
14	LEVEL 3	CORRODED CONDUIT, SUPPORT & J-BOX	V14	120/123	REMOVE & REPLACE SUPPORTING STRAPS AND MOUNTING SUPPORTS WITH ANODIZED ALUMINUM COMPONENTS. REMOVE RUST WITH A WIRE BRUSH, SANDPAPER, ETC. PAINT EXTERIOR METAL COMPONENTS WITH A CORROSION-RESISTANT PRIMER. APPLY MATCHING FINISH COAT APPROVED FOR USE. REPLACE J-BOX COVER AND GASKET.	EACH	1
15	LEVEL 3	CORRODED CONDUIT, SUPPORT, & COUPLING	V15	120/123	LOCK OUT BREAKER, TAG, IDENTIFY, AND REMOVE CONDUCTORS TO THE NEAREST UNDAMAGED JUNCTION BOX OR POINT OF TERMINATION. CUT AND/OR REMOVE THE CORRODED CONDUIT BODY AND/OR PORTION OF CORRODED CONDUIT AND SUPPORTS. RE-THREAD AND REASSEMBLE. RECONNECT CONDUCTORS. CLOSE BREAKER AND TEST TO CONFIRM CABLE INSULATION INTEGRITY AND PROPER VOLTAGE. REPLACE CABLING, IF NECESSARY.	EACH	1
16	LEVEL 3	CORRODED CONDUIT SUPPORT	V16	120/123	REMOVE & REPLACE SUPPORTING STRAPS AND MOUNTING SUPPORTS WITH ANODIZED ALUMINUM COMPONENTS. REMOVE RUST WITH A WIRE BRUSH, SANDPAPER, ETC. PAINT EXTERIOR METAL COMPONENTS WITH A CORROSION-RESISTANT PRIMER. APPLY MATCHING FINISH COAT APPROVED FOR USE.	EACH	1
17	LEVEL 3	CONDUIT BODY OR ENCLOSURE (J-BOX) COVER MISSING OR OPENED	V17	124	CLOSE COVER AND GASKET OVER THE CONDUIT BODY OR ENCLOSURE. REPLACE COVER AND GASKET, IF REQUIRED.	EACH	1
18	LEVEL 1 & 3	CORRODED CONDUIT SUPPORT	V18	123	REMOVE & REPLACE SUPPORTING STRAPS AND MOUNTING SUPPORTS WITH ANODIZED ALUMINUM COMPONENTS. REMOVE RUST WITH A WIRE BRUSH, SANDPAPER, ETC. PAINT EXTERIOR METAL COMPONENTS WITH A CORROSION-RESISTANT PRIMER. APPLY MATCHING FINISH COAT APPROVED FOR USE.	EACH	MULTII
19	LEVEL 3	CORRODED CONDUIT, SUPPORT, & J-BOX	V19	120/123	LOCK OUT BREAKER, TAG, IDENTIFY, AND REMOVE CONDUCTORS TO THE NEAREST UNDAMAGED JUNCTION BOX OR POINT OF TERMINATION. CUT AND/OR REMOVE THE CORRODED CONDUIT BODY AND/OR PORTION OF CORRODED CONDUIT AND SUPPORTS. REPLACE IN KIND. RE-THREAD AND REASSEMBLE. RECONNECT CONDUCTORS. CLOSE BREAKER AND TEST TO CONFIRM CABLE INSULATION INTEGRITY AND PROPER VOLTAGE. REPLACE CABLING, IF NECESSARY.	EACH	1
20	LEVEL 3	CORRODED CONDUIT & SUPPORT	V20	123	LOCK OUT BREAKER, TAG, IDENTIFY, AND REMOVE CONDUCTORS TO THE NEAREST UNDAMAGED JUNCTION BOX OR POINT OF TERMINATION. CUT AND/OR REMOVE THE CORRODED CONDUIT BODY AND/OR PORTION OF CORRODED CONDUIT AND SUPPORTS. RE-THREAD AND REASSEMBLE. RECONNECT CONDUCTORS. CLOSE BREAKER AND TEST TO CONFIRM CABLE INSULATION INTEGRITY AND PROPER VOLTAGE. REPLACE CABLING, IF NECESSARY.	EACH	1
21	LEVEL 3	CORRODED CONDUIT SUPPORT	V21	123	REMOVE & REPLACE SUPPORTING STRAPS AND MOUNTING SUPPORTS WITH ANODIZED ALUMINUM COMPONENTS. REMOVE RUST WITH A WIRE BRUSH, SANDPAPER, ETC. PAINT EXTERIOR METAL COMPONENTS WITH A CORROSION-RESISTANT PRIMER. APPLY MATCHING FINISH COAT APPROVED FOR USE.	EACH	1
22	LEVEL 3	CORRODED CONDUIT & J-BOX	V22	120/123	LOCK OUT BREAKER, TAG, IDENTIFY, AND REMOVE CONDUCTORS TO THE NEAREST UNDAMAGED JUNCTION BOX OR POINT OF TERMINATION. CUT AND/OR REMOVE THE CORRODED CONDUIT BODY AND/OR PORTION OF CORRODED CONDUIT AND SUPPORTS. RE-THREAD AND REASSEMBLE. RECONNECT CONDUCTORS. CLOSE BREAKER AND TEST TO CONFIRM CABLE INSULATION INTEGRITY AND PROPER VOLTAGE. REPLACE CABLING, IF NECESSARY.	EACH	1
23	LEVEL 2 & 3	CORRODED CONDUIT SUPPORT	V23	120/123	REMOVE & REPLACE SUPPORTING STRAPS AND MOUNTING SUPPORTS WITH ANODIZED ALUMINUM COMPONENTS. REMOVE RUST WITH A WIRE BRUSH, SANDPAPER, ETC. PAINT EXTERIOR METAL COMPONENTS WITH A CORROSION-RESISTANT PRIMER. APPLY MATCHING FINISH COAT APPROVED FOR USE.	EACH	1

ITEM No.	LOCATION	DEFICIENCY DESCRIPTION	PHOTO No.	CORRECTIVE	REPAIR DESCRIPTION	UNIT OF QTY.	NO. OF
ITEM NO.	LOCATION	DEFICIENCY DESCRIPTION	PHOTO No.	ACTION No.	LOCK OUT BREAKER, TAG, IDENTIFY, AND REMOVE CONDUCTORS TO THE NEAREST UNDAMAGED JUNCTION BOX OR POINT OF	UNIT OF QTY.	LOCATIONS
24	LEVEL 3	CORRODED J-BOX & CONDUIT SUPPORTS	V24	123	TERMINATION. CUT AND/OR REMOVE THE CORRODED CONDUIT BODY AND/OR PORTION OF CORRODED CONDUIT AND SUPPORTS. RE-THREAD AND REASSEMBLE. RECONNECT CONDUCTORS. CLOSE BREAKER AND TEST TO CONFIRM CABLE INSULATION INTEGRITY AND PROPER VOLTAGE. REPLACE CABLING, IF NECESSARY.	EACH	1
25	LEVEL 3	CORRODED CONDUIT COUPLING	V25	120/123	LOCK OUT BREAKER, TAG, IDENTIFY, AND REMOVE CONDUCTORS TO THE NEAREST UNDAMAGED JUNCTION BOX OR POINT OF TERMINATION. CUT AND/OR REMOVE THE CORRODED CONDUIT BODY AND/OR PORTION OF CORRODED CONDUIT AND SUPPORTS. RE-THREAD AND REASSEMBLE. RECONNECT CONDUCTORS. CLOSE BREAKER AND TEST TO CONFIRM CABLE INSULATION INTEGRITY AND PROPER VOLTAGE. REPLACE CABLING, IF NECESSARY.	EACH	1
26	LEVEL 4	LIGHTING POLE - ACCESS COVER MISSING	V26	116	REPLACE LIGHTING POLE COVER AND GASKET.	EACH	2
27	LEVEL 1	CORRODED GENERATOR ENCLOSURE	V27	118	REMOVE RUST WITH A WIRE BRUSH, SANDPAPER, ETC. PAINT EXTERIOR METAL COMPONENTS WITH A CORROSION-RESISTANT PRIMER. APPLY MATCHING FINISH COAT.	<u>EACH</u>	<u>1</u>
28	LEVEL 1	LIGHTS NOT ILLUMINATED (DIRECTIONAL)	V28	110	VERIFY CIRCUIT IS ENERGIZED AT THE PROPER VOLTAGE. IF ELECTRICAL POWER IS PRESENT, LOCK OUT BREAKER, IDENTIFY, TAG, AND DISCONNECT THE CONDUCTORS FROM THE DEFECTIVE DEVICE. REMOVE THE DEFECTIVE DEVICE AND REPLACE IN KIND. CLOSE BREAKER AND TEST TO CONFIRM CABLE INSULATION INTEGRITY AND PROPER VOLTAGE.	<u>EACH</u>	MULTIPLE
29	LEVEL 4	RECEPTACLES - DAMAGED OR BURNT	V29	125	LOCK OUT BREAKER, IDENTIFY, TAG, AND DISCONNECT THE CONDUCTORS FROM THE DEFECTIVE DEVICE. REMOVE THE DEFECTIVE DEVICE AND REPLACE IN KIND. CLOSE BREAKER AND TEST TO CONFIRM CABLE INSULATION INTEGRITY AND PROPER VOLTAGE. REPLACE CABLING, IF NECESSARY.	<u>EACH</u>	1
30	LEVEL 4	RECEPTACLES - DAMAGED OR BURNT	V30	125	LOCK OUT BREAKER, IDENTIFY, TAG, AND DISCONNECT THE CONDUCTORS FROM THE DEFECTIVE DEVICE. REMOVE THE DEFECTIVE DEVICE AND REPLACE IN KIND. CLOSE BREAKER AND TEST TO CONFIRM CABLE INSULATION INTEGRITY AND PROPER VOLTAGE. REPLACE CABLING, IF NECESSARY.	EACH	1
31	LEVEL 4	RECEPTACLES - DAMAGED OR BURNT	V31	125	LOCK OUT BREAKER, IDENTIFY, TAG, AND DISCONNECT THE CONDUCTORS FROM THE DEFECTIVE DEVICE. REMOVE THE DEFECTIVE DEVICE AND REPLACE IN KIND. CLOSE BREAKER AND TEST TO CONFIRM CABLE INSULATION INTEGRITY AND PROPER VOLTAGE. REPLACE CABLING, IF NECESSARY.	EACH	1
32	LEVEL 3	RECEPTACLES - DAMAGED OR BURNT	V32	125	LOCK OUT BREAKER, IDENTIFY, TAG, AND DISCONNECT THE CONDUCTORS FROM THE DEFECTIVE DEVICE. REMOVE THE DEFECTIVE DEVICE AND REPLACE IN KIND. CLOSE BREAKER AND TEST TO CONFIRM CABLE INSULATION INTEGRITY AND PROPER VOLTAGE. REPLACE CABLING, IF NECESSARY.	EACH	1
33	LEVEL 2	CORRODED J-BOX	V33	123	LOCK OUT BREAKER, TAG, IDENTIFY, AND REMOVE CONDUCTORS TO THE NEAREST UNDAMAGED JUNCTION BOX OR POINT OF TERMINATION. CUT AND/OR REMOVE THE CORRODED CONDUIT BODY AND/OR PORTION OF CORRODED CONDUIT AND SUPPORTS. RE-THREAD AND REASSEMBLE. RECONNECT CONDUCTORS. CLOSE BREAKER AND TEST TO CONFIRM CABLE INSULATION INTEGRITY AND PROPER VOLTAGE. REPLACE CABLING, IF NECESSARY.	EACH	1
34	LEVEL 1 & 2	LIGHTS NOT ILLUMINATED (EXIT)	V34	104	VERIFY CIRCUIT IS ENERGIZED AT THE PROPER VOLTAGE. IF ELECTRICAL POWER IS PRESENT, LOCK OUT BREAKER, IDENTIFY, TAG, AND DISCONNECT THE CONDUCTORS FROM THE DEFECTIVE DEVICE. REMOVE THE DEFECTIVE DEVICE AND REPLACE IN KIND. CLOSE BREAKER AND TEST TO CONFIRM CABLE INSULATION INTEGRITY AND PROPER VOLTAGE.	EACH	1
35	LEVEL 1	CORRODED CONDUIT	V35	120	LOCK OUT BREAKER, TAG, IDENTIFY, AND REMOVE CONDUCTORS TO THE NEAREST UNDAMAGED JUNCTION BOX OR POINT OF TERMINATION. CUT AND/OR REMOVE THE CORRODED CONDUIT BODY AND/OR PORTION OF CORRODED CONDUIT AND SUPPORTS. RE-THREAD AND REASSEMBLE. RECONNECT CONDUCTORS. CLOSE BREAKER AND TEST TO CONFIRM CABLE INSULATION INTEGRITY AND PROPER VOLTAGE. REPLACE CABLING, IF NECESSARY.	10 FT.	1
36	LEVEL 1	MISSING WALL HEATER COVER	V36	117	REPLACE WALL HEATER COVER IN KIND, IF POSSIBLE. OTHERWISE LOCK OUT BREAKER, IDENTIFY, TAG, AND DISCONNECT THE CONDUCTORS FROM THE DEFECTIVE DEVICE. REMOVE THE DEFECTIVE DEVICE AND REPLACE IN KIND. CLOSE BREAKER AND TEST.	EACH	1
37	LEVEL 1	CORRODED CONDUIT	V37	120	LOCK OUT BREAKER, TAG, IDENTIFY, AND REMOVE CONDUCTORS TO THE NEAREST UNDAMAGED JUNCTION BOX OR POINT OF TERMINATION. CUT AND/OR REMOVE THE CORRODED CONDUIT BODY AND/OR PORTION OF CORRODED CONDUIT AND SUPPORTS. RE-THREAD AND REASSEMBLE. RECONNECT CONDUCTORS. CLOSE BREAKER AND TEST TO CONFIRM CABLE INSULATION INTEGRITY AND PROPER VOLTAGE. REPLACE CABLING, IF NECESSARY.	10 FT.	1
38	LEVEL 1	MISSING WALL HEATER COVER	V38	117	REPLACE WALL HEATER COVER IN KIND, IF POSSIBLE. OTHERWISE LOCK OUT BREAKER, IDENTIFY, TAG, AND DISCONNECT THE CONDUCTORS FROM THE DEFECTIVE DEVICE. REMOVE THE DEFECTIVE DEVICE AND REPLACE IN KIND. CLOSE BREAKER AND TEST.	EACH	1
39	LEVEL 1	CORRODED WIRE TROUGH	V39	123	REMOVE & REPLACE SUPPORTING STRAPS AND MOUNTING SUPPORTS WITH ANODIZED ALUMINUM COMPONENTS. REMOVE RUST WITH A WIRE BRUSH, SANDPAPER, ETC. PAINT EXTERIOR METAL COMPONENTS WITH A CORROSION-RESISTANT PRIMER. APPLY MATCHING FINISH COAT APPROVED FOR USE.	EACH	1
40	LEVEL 1	CORRODED CONDUIT SUPPORT	V40	123	REMOVE & REPLACE SUPPORTING STRAPS AND MOUNTING SUPPORTS WITH ANODIZED ALUMINUM COMPONENTS. REMOVE RUST WITH A WIRE BRUSH, SANDPAPER, ETC. PAINT EXTERIOR METAL COMPONENTS WITH A CORROSION-RESISTANT PRIMER. APPLY MATCHING FINISH COAT APPROVED FOR USE.	EACH	1
41	LEVEL 4	MISSING LIGHT FIXTURE	V41	103	VERIFY CIRCUIT IS ENERGIZED AT THE PROPER VOLTAGE. IF ELECTRICAL POWER IS PRESENT LOCK OUT BREAKER, TAG, IDENTIFY, AND REMOVE CONDUCTORS TO THE NEAREST UNDAMAGED JUNCTION BOX OR POINT OF TERMINATION. REPLACE FIXTURE IN KIND WITH APPROVED LED FIXTURE. CLOSE BREAKER AND TEST TO CONFIRM CABLE INSULATION INTEGRITY AND PROPER VOLTAGE. REPLACE CABLING, IF NECESSARY.	EACH	1
42	LEVEL 1	CORRODED CONDUIT & J-BOX	V42	120/123	LOCK OUT BREAKER, TAG, IDENTIFY, AND REMOVE CONDUCTORS TO THE NEAREST UNDAMAGED JUNCTION BOX OR POINT OF TERMINATION. CUT AND/OR REMOVE THE CORRODED CONDUIT BODY AND/OR PORTION OF CORRODED CONDUIT AND SUPPORTS. RE-THREAD AND REASSEMBLE. RECONNECT CONDUCTORS. CLOSE BREAKER AND TEST TO CONFIRM CABLE INSULATION INTEGRITY AND PROPER VOLTAGE. REPLACE CABLING, IF NECESSARY.	EACH	1
43	LEVEL 2	CORRODED CONDUIT & J-BOX	V43	120/123	LOCK OUT BREAKER, TAG, IDENTIFY, AND REMOVE CONDUCTORS TO THE NEAREST UNDAMAGED JUNCTION BOX OR POINT OF TERMINATION. CUT AND/OR REMOVE THE CORRODED CONDUIT BODY AND/OR PORTION OF CORRODED CONDUIT AND SUPPORTS. RE-THREAD AND REASSEMBLE. RECONNECT CONDUCTORS. CLOSE BREAKER AND TEST TO CONFIRM CABLE INSULATION INTEGRITY AND PROPER VOLTAGE. REPLACE CABLING, IF NECESSARY.	EACH	1
44	LEVEL 2	CORRODED CONDUIT SUPPORT	V44	123	REMOVE & REPLACE SUPPORTING STRAPS AND MOUNTING SUPPORTS WITH ANODIZED ALUMINUM COMPONENTS. REMOVE RUST WITH A WIRE BRUSH, SANDPAPER, ETC. PAINT EXTERIOR METAL COMPONENTS WITH A CORROSION-RESISTANT PRIMER. APPLY MATCHING FINISH COAT APPROVED FOR USE.	EACH	1
45	LEVEL 2	CORRODED CONDUIT SUPPORT & J-BOX	V45	123	LOCK OUT BREAKER, TAG, IDENTIFY, AND REMOVE CONDUCTORS TO THE NEAREST UNDAMAGED JUNCTION BOX OR POINT OF TERMINATION. CUT AND/OR REMOVE THE CORRODED CONDUIT BODY AND/OR PORTION OF CORRODED CONDUIT AND SUPPORTS. RE-THREAD AND REASSEMBLE. RECONNECT CONDUCTORS. CLOSE BREAKER AND TEST TO CONFIRM CABLE INSULATION INTEGRITY AND PROPER VOLTAGE. REPLACE CABLING, IF NECESSARY.	EACH	1

SUMMARY OF ELECTRICAL DEFICIENCIES TABLE - VIENNA NORTH GARAGE



CORRECTIVE ACTION NUMBER 123

CORRODED CONDUIT SUPPORT K08-E-501 SCALE: N.T.S.




CORRECTIVE ACTION NUMBER 123

CORRODED CONDUIT SUPPORT K08-E-502 SCALE: N.T.S.



CORRECTIVE ACTION NUMBER 123

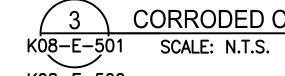

CORRODED CONDUIT SUPPORT

K08-E-502

REHABILITATION OF WMATA PARKING FACILITIES K08 - VIENNA NORTH PARKING GARAGE ELECTRICAL

A Gannett Fleming/Parsons
JOINT VENTURE

				REFERENCE DRAWINGS	REVISIONS			
550101155	M. RICHARDS	01/2018	NUMBER	TITLE	DATE	NUM	DESCRIPTION	
DESIGNED	W. KICHAKDS	DATE			01/25/2018	0	FINAL SUBMITTAL	
DRAWN	R. PINNICK	01/2018						
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CHECKED	M. RICHARDS	01/2018						
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	Metro*	WASHINGTON METROPOLITAN AREA TRANSIT AUTHORIT
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OFFICE OF DESIGN AND CONSTRUCTION
IRPG - FIXED FACILITIES Monte A. Kichards

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JOHN PURDY ENGINEERING MANA	CER	DATE	MONTE A. RICHARDS	,
ENGINEERING MANA	GER		ENGINEER OF RECO	Kυ

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01/25/2018	M NO.
DATE	M1301

	DE	DEFICIENCY PHOTOGRAPHS CORRECTIVE ACTIONS REQUIRED								
25/2018	M NO.	CONTRACT NO.	SCALE	DRAWING NO.	SHEET NO.					
DATE	M1301	FQ18064	N.T.S.	K08-E-509	476 of 503					



CORRECTIVE ACTION NUMBER 120

4 CORRODED CONDUIT

K08-E-502 SCALE: N.T.S.

K08-E-506



CORRECTIVE ACTION NUMBER 120, 123

8 CORRODED CONDUIT COUPLINGS

(08-E-502 SCALE: N.T.S.



5 CORRODED CONDUIT / CORRODED J-BOX



9 CORRODED CONDUIT SUPPORT K08-E-503 SCALE: N.T.S.



6 CORRODED CONDUIT SPPORT K08-E-501 SCALE: N.T.S.



CORRECTIVE ACTION NUMBER 120, 123

10 CORRODED CONDUIT AND SUPPORT
-E-504 SCALE: N.T.S.



CORRECTIVE ACTION NUMBER

7 CORRODED J-BOX K08-E-502 SCALE: N.T.S.



CORRECTIVE ACTION NUMBER 110

11 NON-FUNCTIONING DIRECTIONAL LIGHT FIXTURE

(08-E-504 SCALE: N.T.S.

A Gannett Fleming/Parsons
JOINT VENTURE

MONTE A. RICHARDS
Lic. No. 0402035948

201/25/2018

				REFERENCE DRAWINGS			REVISIONS			
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WASHINGTON METROPOLITAN AREA TRANSIT AUTHORITY

OFFICE OF DESIGN AND CONSTRUCTION

IRPG - FIXED FACILITIES of one A. Kicharde

APPROVED 01/25/2018

JOHN PURDY DATE

ENGINEERING MANAGER

ACILITIES

APPROVED

MONTE A. RICHARDS, P.E.
ENGINEER OF RECORD

A. Lichards

01/25/2018

DATE

REHABILITATION OF WMATA PARKING FACILITIES

K08 - VIENNA NORTH PARKING GARAGE



CORRECTIVE ACTION NUMBER 120,123

CORRODED CONDUIT / CORRODED J-BOX




CORRECTIVE ACTION NUMBER 120, 123

CORRODED CONDUIT AND SUPPORT SCALE: N.T.S.



CORRODED CONDUIT SUPPORT

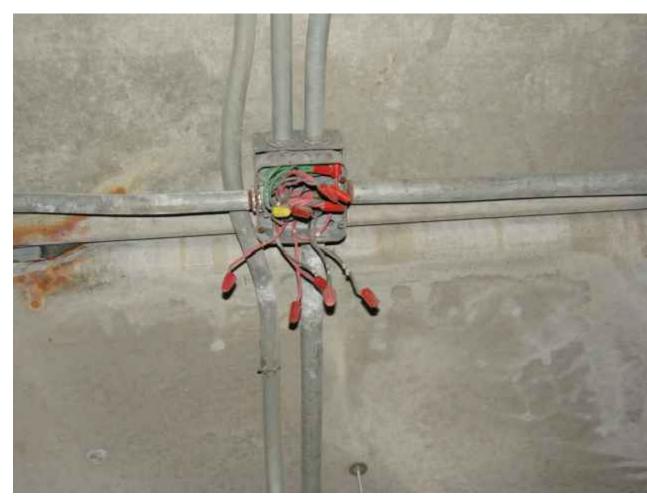

CORRECTIVE ACTION NUMBER

MISSING J-BOX COVER SCALE: N.T.S.



CORRECTIVE ACTION NUMBER 120, 123

CORRODED CONDUIT SPPORT AND J-BOX



CORRECTIVE ACTION NUMBER 123

CORRODED CONDUIT SUPPORT SCALE: N.T.S. K08-E-505



CORRECTIVE ACTION NUMBER 120, 123

CORRODED CONDUIT COUPLING AND SUPPORT



CORRECTIVE ACTION NUMBER 120, 123

CORRODED CONDUIT, SUPPORTS AND J-BOX K08-E-506 SCALE: N.T.S.

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JOINT VENTURE

478 of 503

REHABILITATION OF WMATA PARKING FACILITIES

K08 - VIENNA NORTH PARKING GARAGE

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WASHINGTON METROPOLITAN AREA TRANSIT AUTHORITY OFFICE OF DESIGN AND CONSTRUCTION

MONTE A. RICHARDS, P.E.

ENGINEER OF RECORD

IRPG - FIXED FACILITIES Monte A. Kicharde 01/25/2018 DATE

ELECTRICAL DEFICIENCY PHOTOGRAPHS

CORRECTIVE ACTIONS REQUIRED CONTRACT NO. DRAWING NO. 01/25/2018 M NO. SCALE SHEET NO. FQ18064 N.T.S. K08-E-511



CORRECTIVE ACTION NUMBER

CORRODED CONDUIT SUPPORT

K08-E-504 SCALE: N.T.S.

K08-E-505 K08-E-506



CORRODED CONDUIT SUPPORT

SCALE: N.T.S.



CORRODED CONDUIT SUPPORT SCALE: N.T.S.



CORRODED CONDUIT COUPLING

SCALE: N.T.S.



CORRECTIVE ACTION NUMBER 120, 123 CORRODED CONDUIT SPPORT AND J-BOX SCALE: N.T.S.



CORRODED CONDUIT COUPLING SCALE: N.T.S. K08-E-508



CORRECTIVE ACTION NUMBER 120, 123

CORRODED CONDUIT SUPPORT

K08-E-503 K08-E-505 SCALE: N.T.S.



CORRECTIVE ACTION NUMBER 118

CORRODED GENERATOR ENCLOSURE SCALE: N.T.S.

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JOINT VENTURE

REFERENCE DRAWINGS REVISIONS DESCRIPTION DATE NUM DESIGNED M. RICHARDS 01/2018
DATE 01/25/2018 0 FINAL SUBMITTAL CHECKED M. RICHARDS 01/2018
DATE

WASHINGTON METROPOLITAN AREA TRANSIT AUTHORITY

OFFICE OF DESIGN AND CONSTRUCTION

01/25/2018 JOHN PURDY ENGINEERING MANAGER

IRPG - FIXED FACILITIES Monte A. Kicharde MONTE A. RICHARDS, P.E.

ENGINEER OF RECORD

K08 - VIENNA NORTH PARKING GARAGE ELECTRICAL

REHABILITATION OF WMATA PARKING FACILITIES

DEFICIENCY PHOTOGRAPHS

CORRECTIVE ACTIONS REQUIRED DRAWING NO. 01/25/2018 M NO. CONTRACT NO. SCALE SHEET NO. FQ18064 N.T.S K08-E-512 479 of 503